

# UNIVERSITY MEDICAL CENTER CENTRAL PHARMACY RENOVATION & OFFICE RELOCATION PROPOSAL ITEM #1

602 INDIANA AVENUE LUBBOCK, TX 79415

# INDEX OF SHEETS

CODE & REFERENCE

RI BASEMENT FLOOR-LIFE SAFETY PLAN, SMOKE COMPARTMENT DIAGRAM & STANDARD ACCESSIBLE MOUNTING HEIGHTS

CR2 BASEMENT FLOOR-REFERENCE PLAN & REQUIRED MINIMUM MANEUVERING CLEARANCES AT DOORS

CR3 BASEMENT FLOOR & FIRST FLOOR-PHASING PLANS

# **ARCHITECTURAL**

A1 BASEMENT FLOOR-DEMOLITION PLANS
A2 BASEMENT FLOOR-DIMENSION PLANS

A3 BASEMENT FLOOR-ANNOTATED PLANS

BASEMENT FLOOR-REFLECTED CEILING PLANS

MILLWORK ELEVATIONS

A6 MILLWORK ELEVATIONS
A7 MILLWORK ELEVATIONS

A7 MILLWORK ELEVATION
A8 MILLWORK SECTIONS

A9 DOOR & WINDOW SCHEDULES, DETAILS & PARTITION SCHEDULE

# INTERIOR

ID1 BASEMENT FLOOR-FLOOR FINISH PLANS
ID2 BASEMENT FLOOR-WALL FINISH PLANS

# **MECHANICAL**

MI BASEMENT PLAN-MECHANICAL DEMOLITION

M2 BASEMENT PLAN-MECHANICAL PIPING DEMOLITION

M3 BASEMENT PLAN-MECHANICAL

M4 BASEMENT PLAN-MECHANICAL PIPING
M5 MECHANICAL DETAILS. SCHEDULE & LEGEND

# PLUMBING

P1 BASEMENT PLAN-PLUMBING DEMOLITION

P2 BASEMENT PLAN-PLUMBING SEWER, WASTE & VENT
P3 PLUMBING RISER DIAGRAMS, SCHEDULE, LEGEND & DETAILS


# ELECTRICAL

BASEMENT PLAN-ELECTRICAL DEMOLITION

E2 BASEMENT PLAN-ELECTRICAL LIGHTING


E3 BASEMENT PLAN-ELECTRICAL POWER & COMMUNICATION

E4 OVERALL BASEMENT PLAN-ELECTRICAL ELECTRICAL SCHEDULES & DETAILS

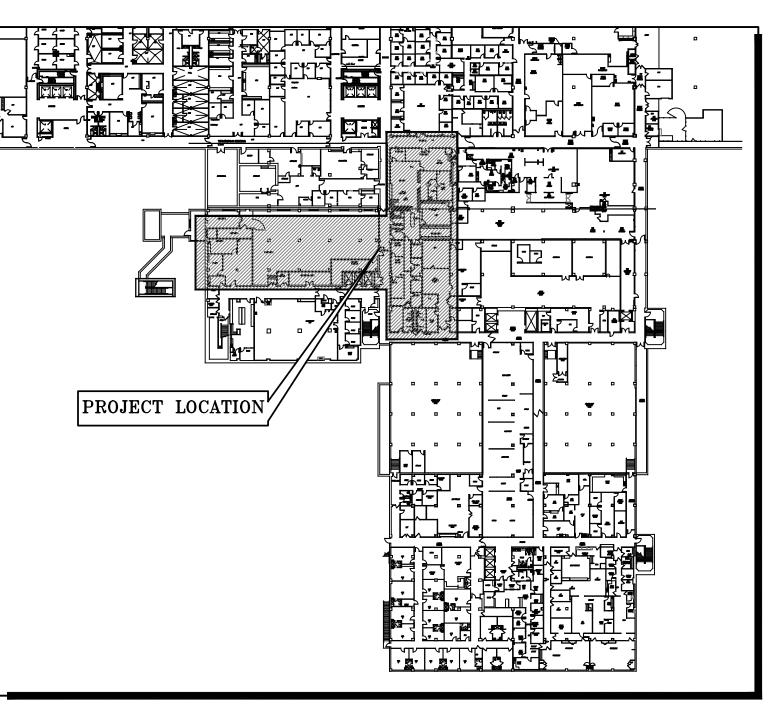

UMC BASEMENT FLOOR LOCATION PLAN



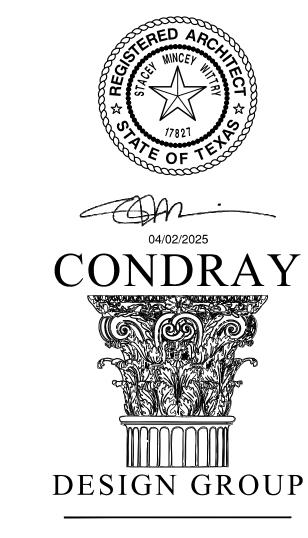

ARCHITECTURE & INTERIOR DESIGN


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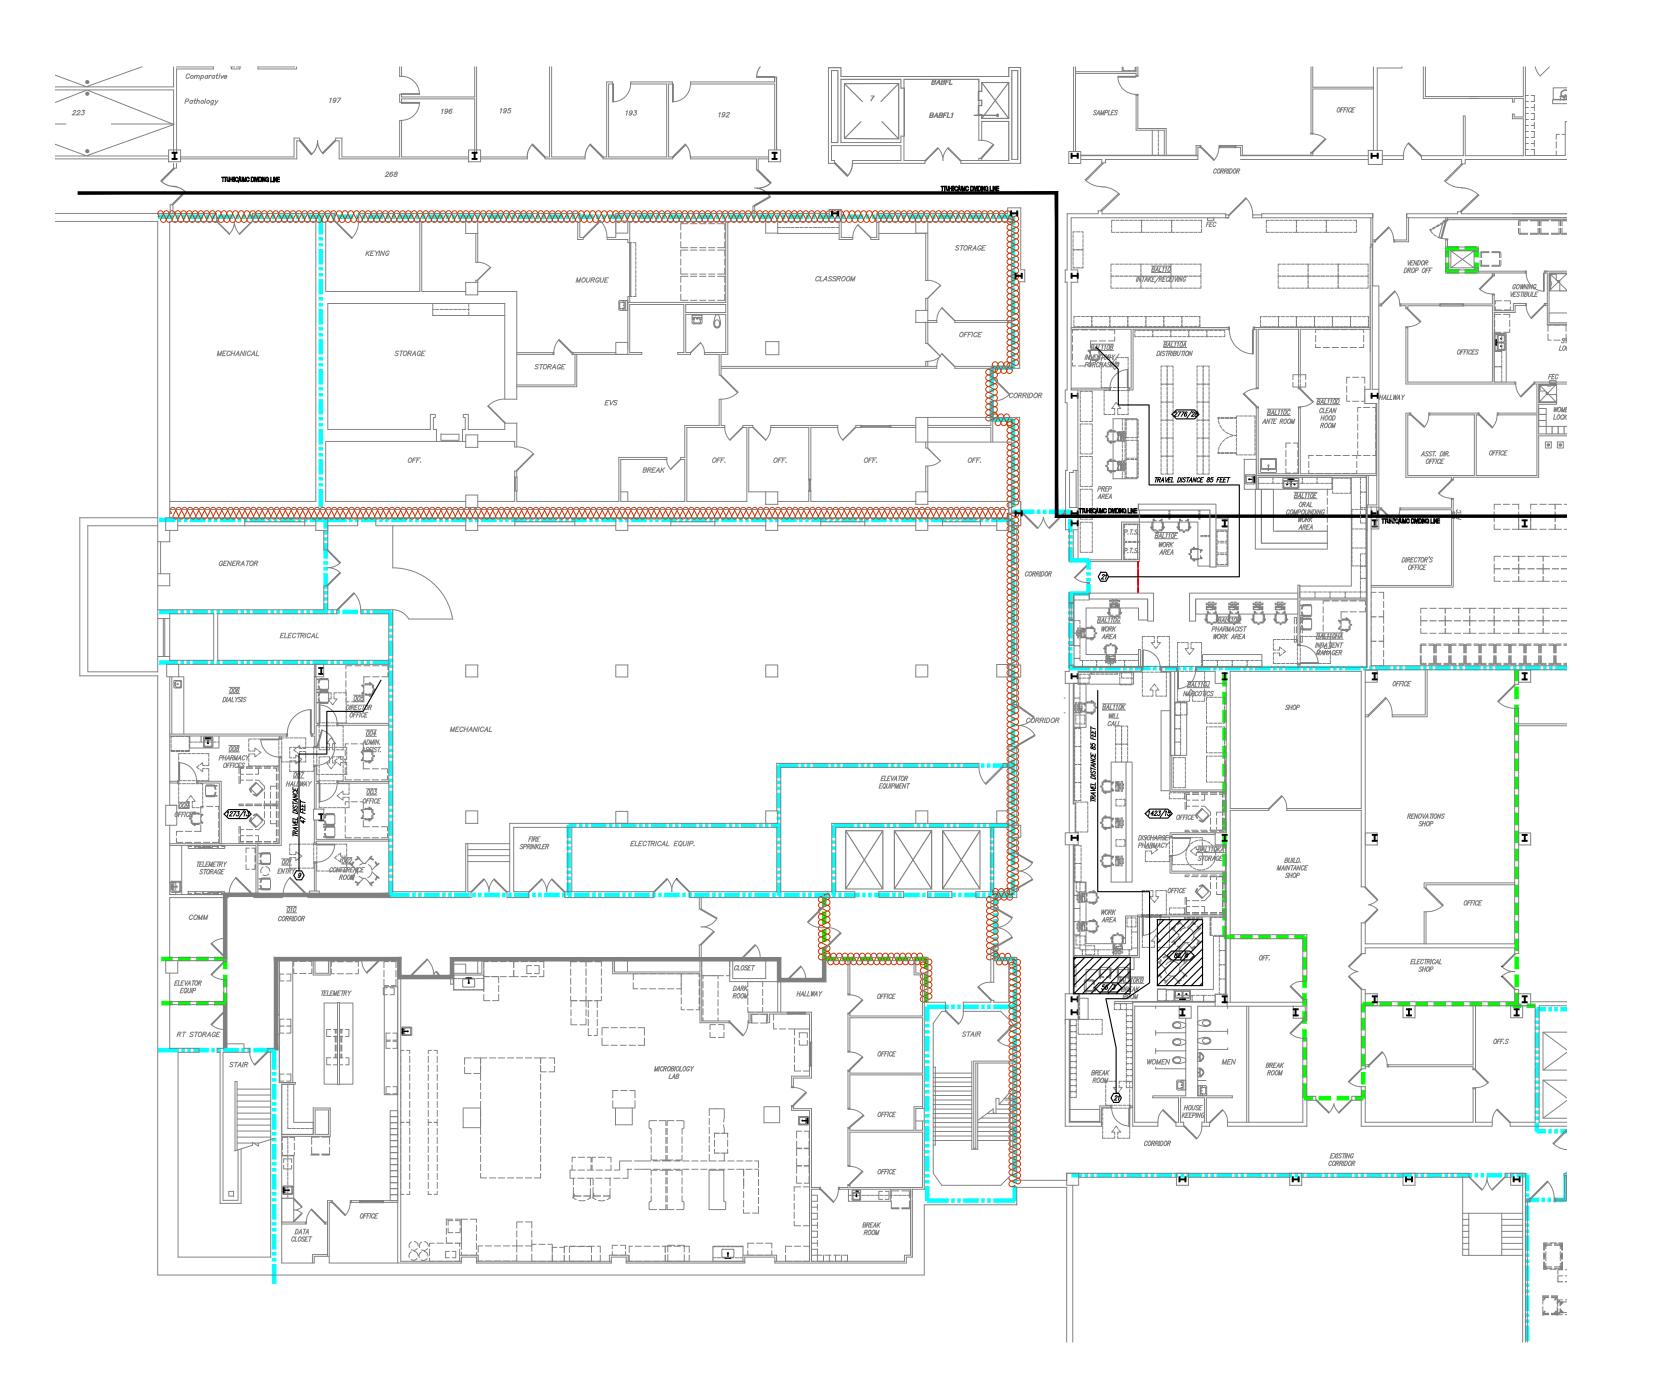



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PROPOSAL ITEM #1

CDG PROJ NO.

22304 04/02/2025



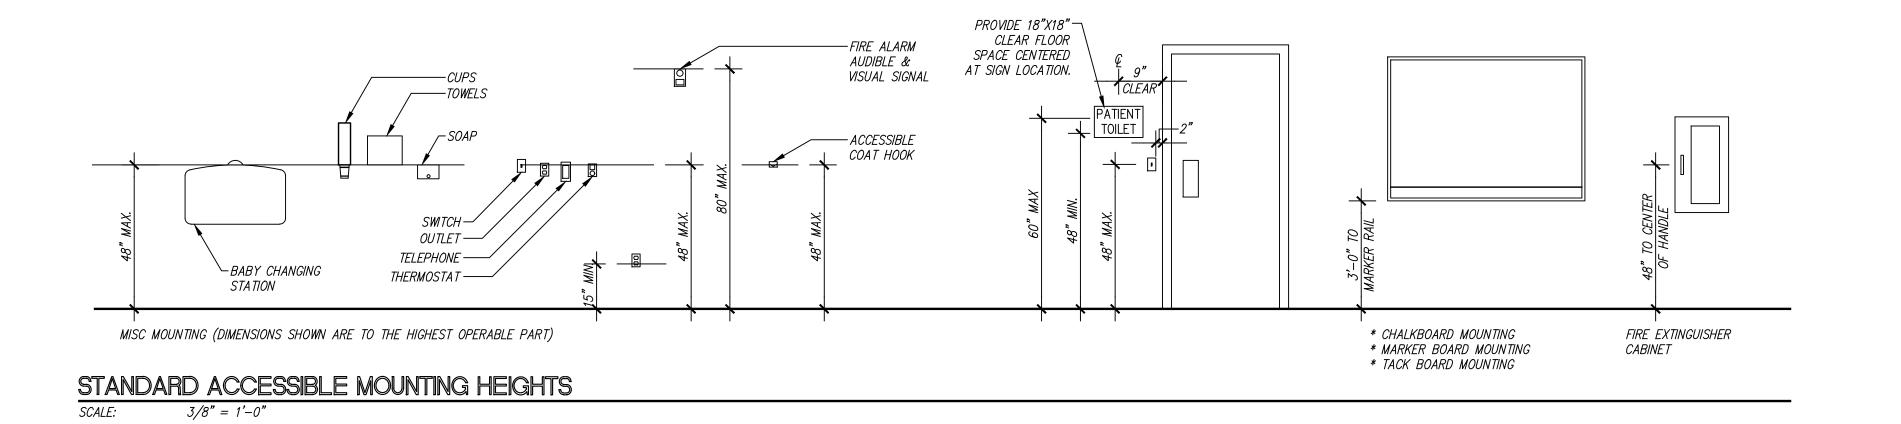

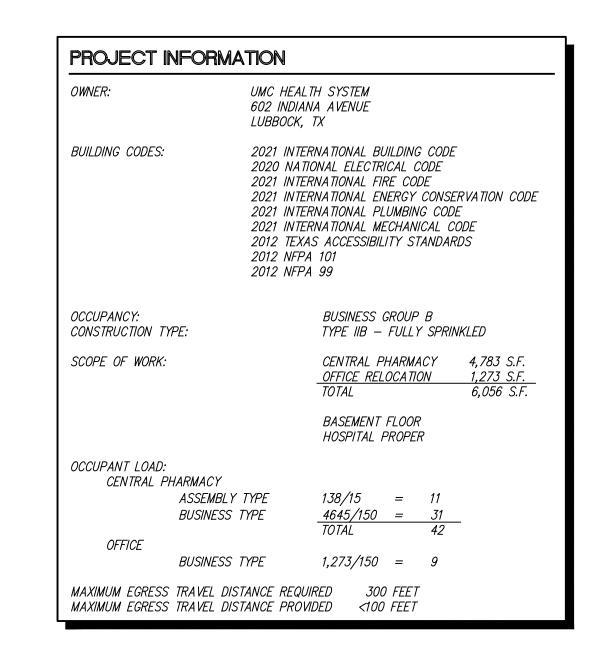

# LIFE SAFETY PLAN LEGEND

FIRE RATED ASSEMBLY LEGEND. AREAS HAVE BEEN SHOWN OUTSIDE THE AREA OF WORK FOR REFERENCE ONLY. THE CONTRACTOR'S RESPONSIBILITY FOR CONSTRUCTION OR MAINTENANCE OF FIRE RATED ASSEMBLIES IS LIMITED ONLY TO THE AREAS OF WORK.

2-HOUR FIRE-RATED ASSEMBLY
FRAME NEW WALLS TO DECK AND SEAL
TOP AND BOTTOM JOINTS WITH UL RATED JOINT
SYSTEMS. AT EXISTING WALLS, EXTEND TO DECK
ABOVE AS NECESSARY AND SEAL JOINTS.

SEALED WITH UL RATED SYSTEMS.

1—HOUR FIRE—RATED ASSEMBLY
FRAME NEW WALLS TO DECK AND SEAL
TOP AND BOTTOM JOINTS WITH UL RATED JOINT
SYSTEMS. AT EXISTING WALLS, EXTEND TO DECK
ABOVE AS NECESSARY AND SEAL JOINTS.
ALL PENETRATIONS, NEW OR EXISTING, ARE TO BE

ALL PENETRATIONS, NEW OR EXISTING, ARE TO BE

SMOKE BARRIER

1-HOUR FIRE-RATED ASSEMBLY AS DESCRIBED ABOVE.

SEALED WITH UL RATED SYSTEMS.


NON—RATED SMOKE PARTITION
WALL PARTITION THAT IS NOT FIRE RATED AND DOES
NOT EXTEND TO STRUCTURAL DECK ABOVE. WALL MAY
TERMINATE 6" ABOVE CEILING. MUST PREVENT
PASSAGE OF SMOKE

DOOR APPROACH AND CLEARANCE.

OCCUPANT LOAD FACTORS: ASSEMBLY AREA = 1 PERSON PER 15 SQFT BUSINESS AREA = 1 PERSON PER 100 SQFT

700/? ROOM SQUARE FOOTAGE/NUMBER OF OCCUPANTS

COLLECTIVE NUMBER OF OCCUPANTS ACCESSING EXIT

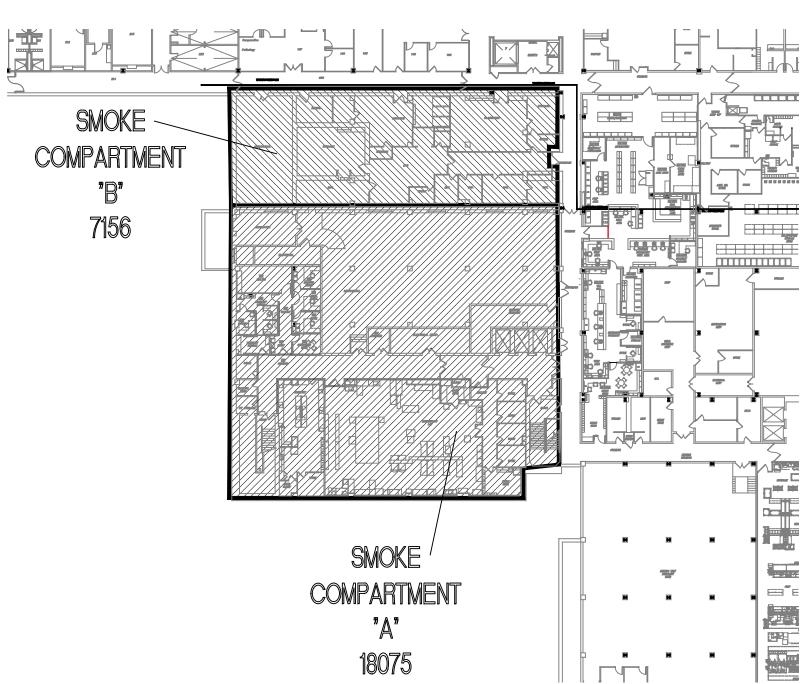

08/CR1 BASEMENT FLOOR-SMOKE COMPARTMENT DIAGRAM

SCALE: NOT TO SCALE






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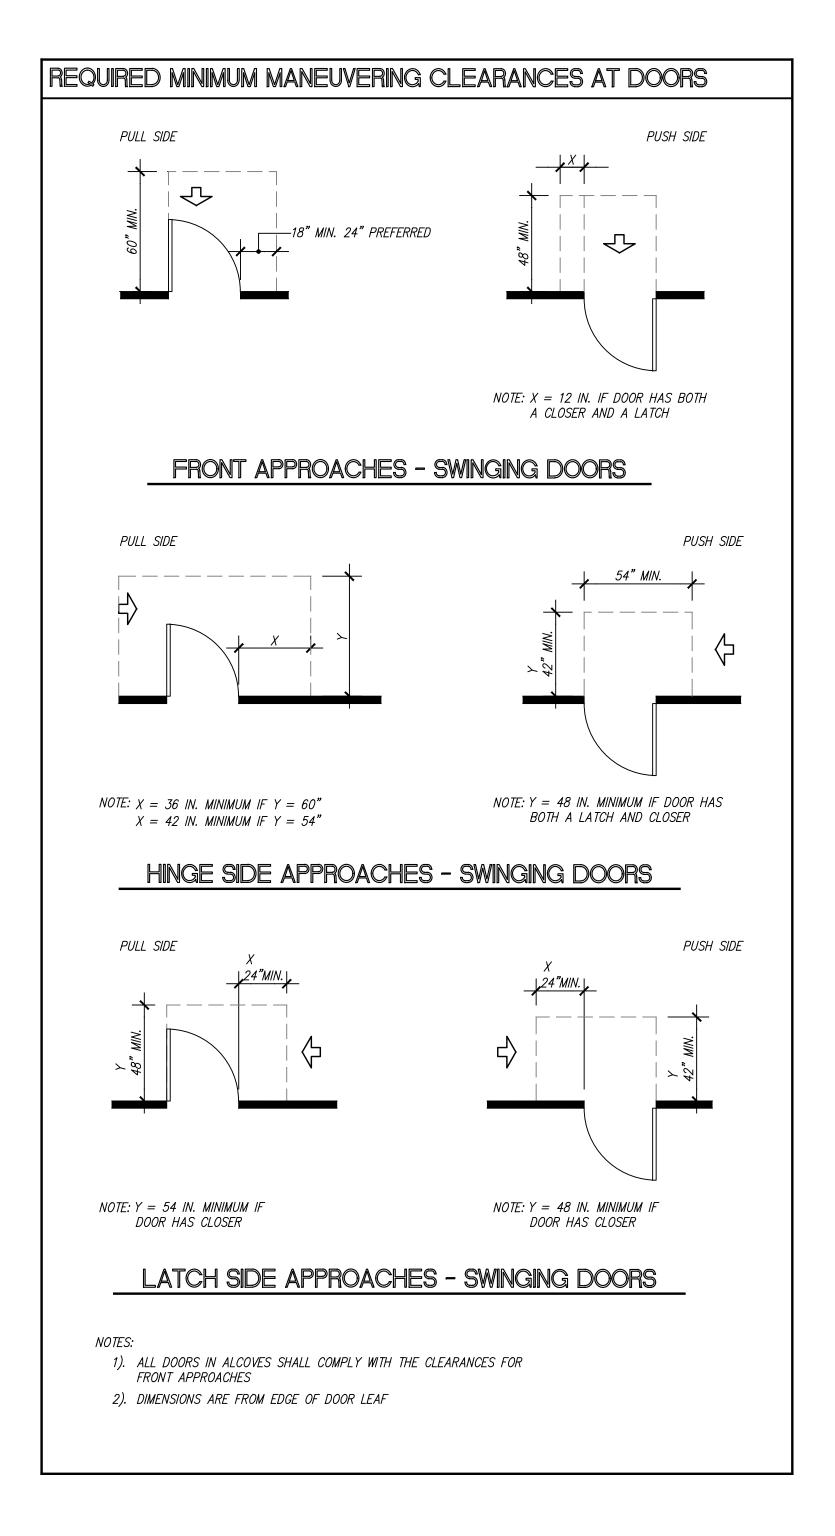
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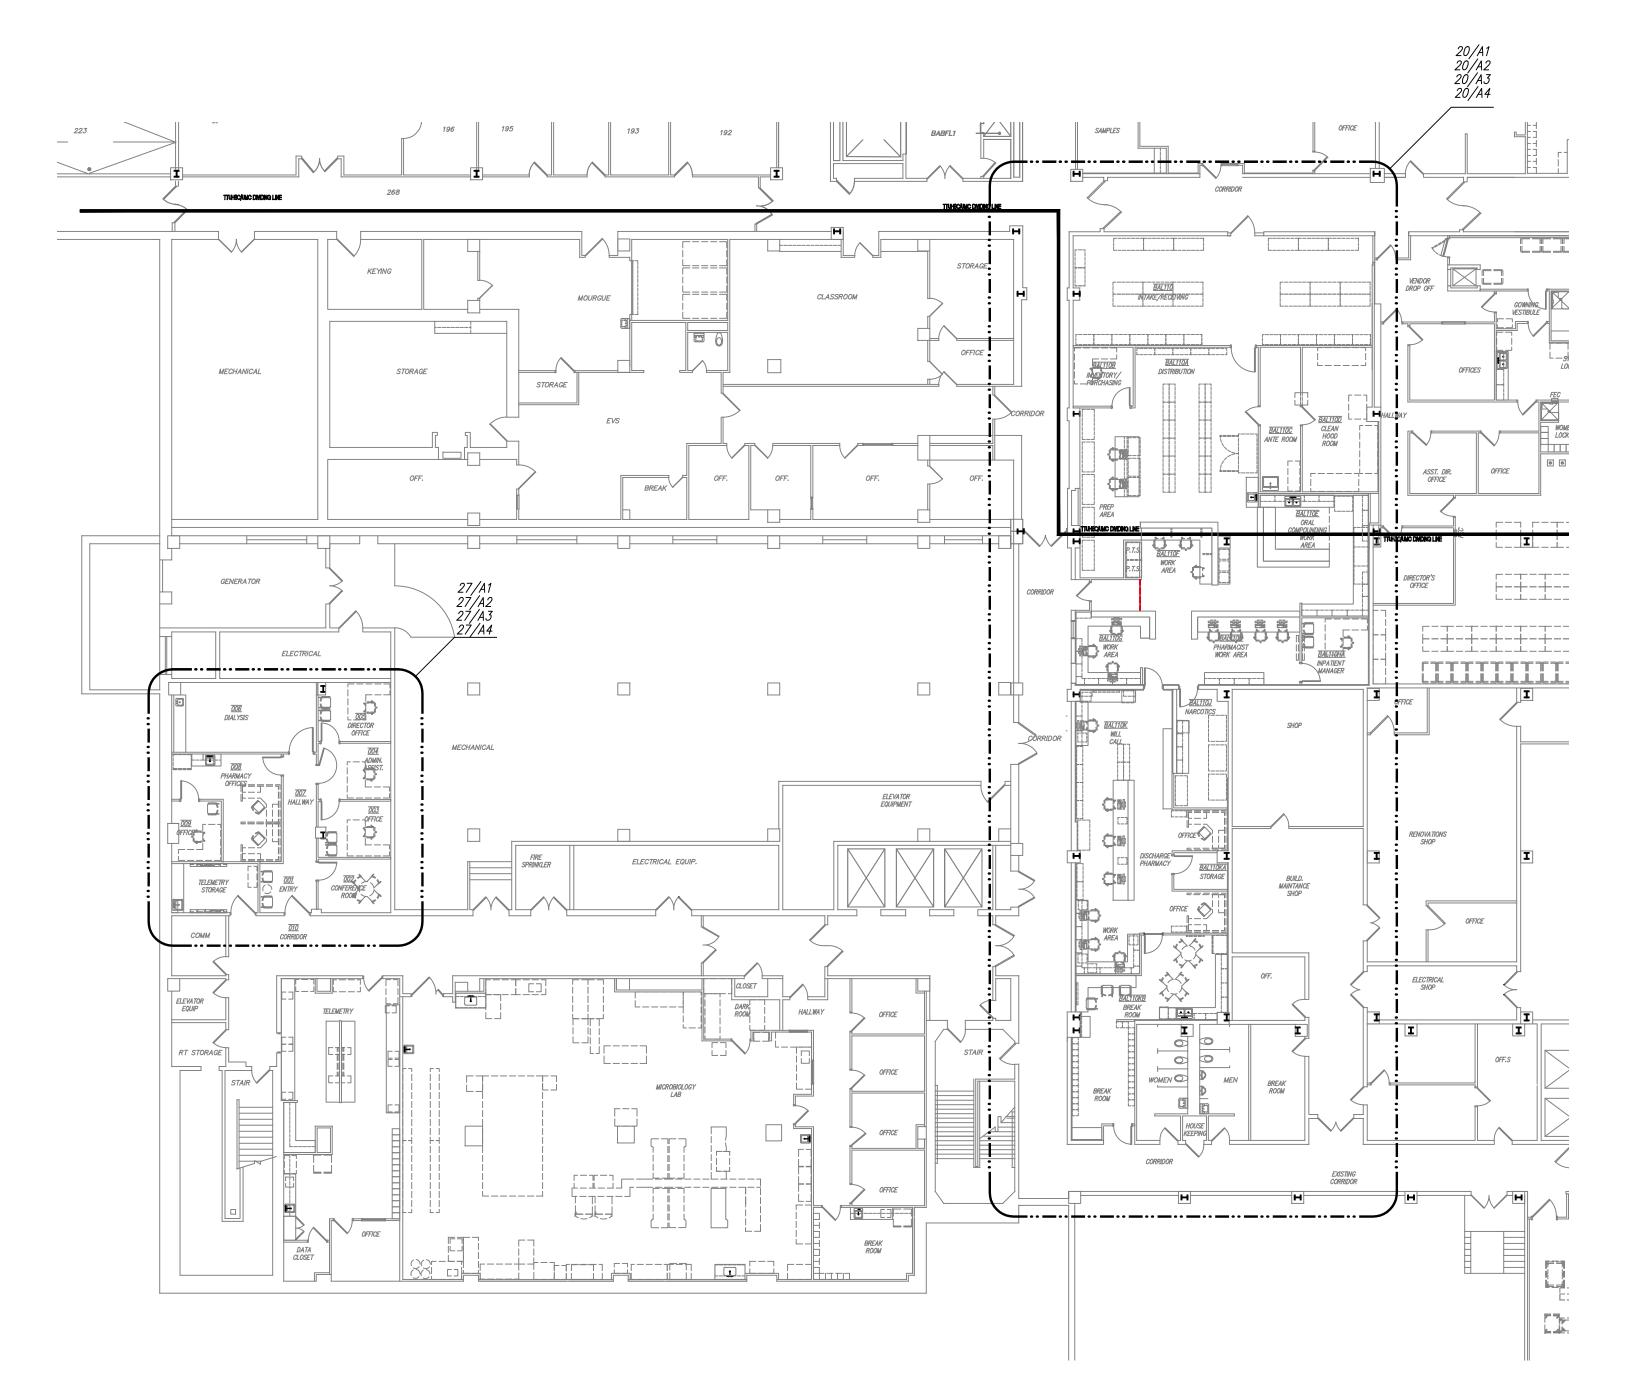
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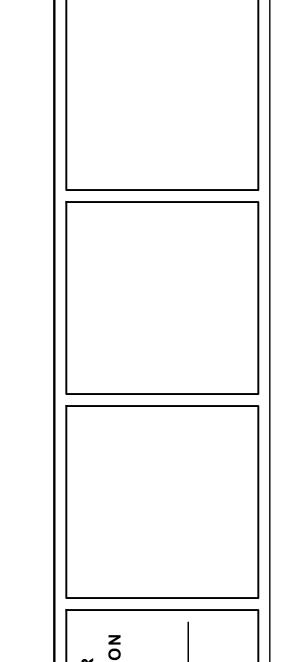









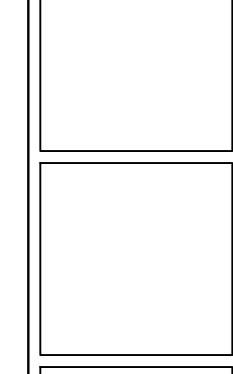



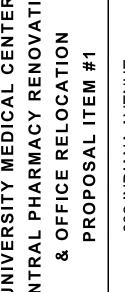


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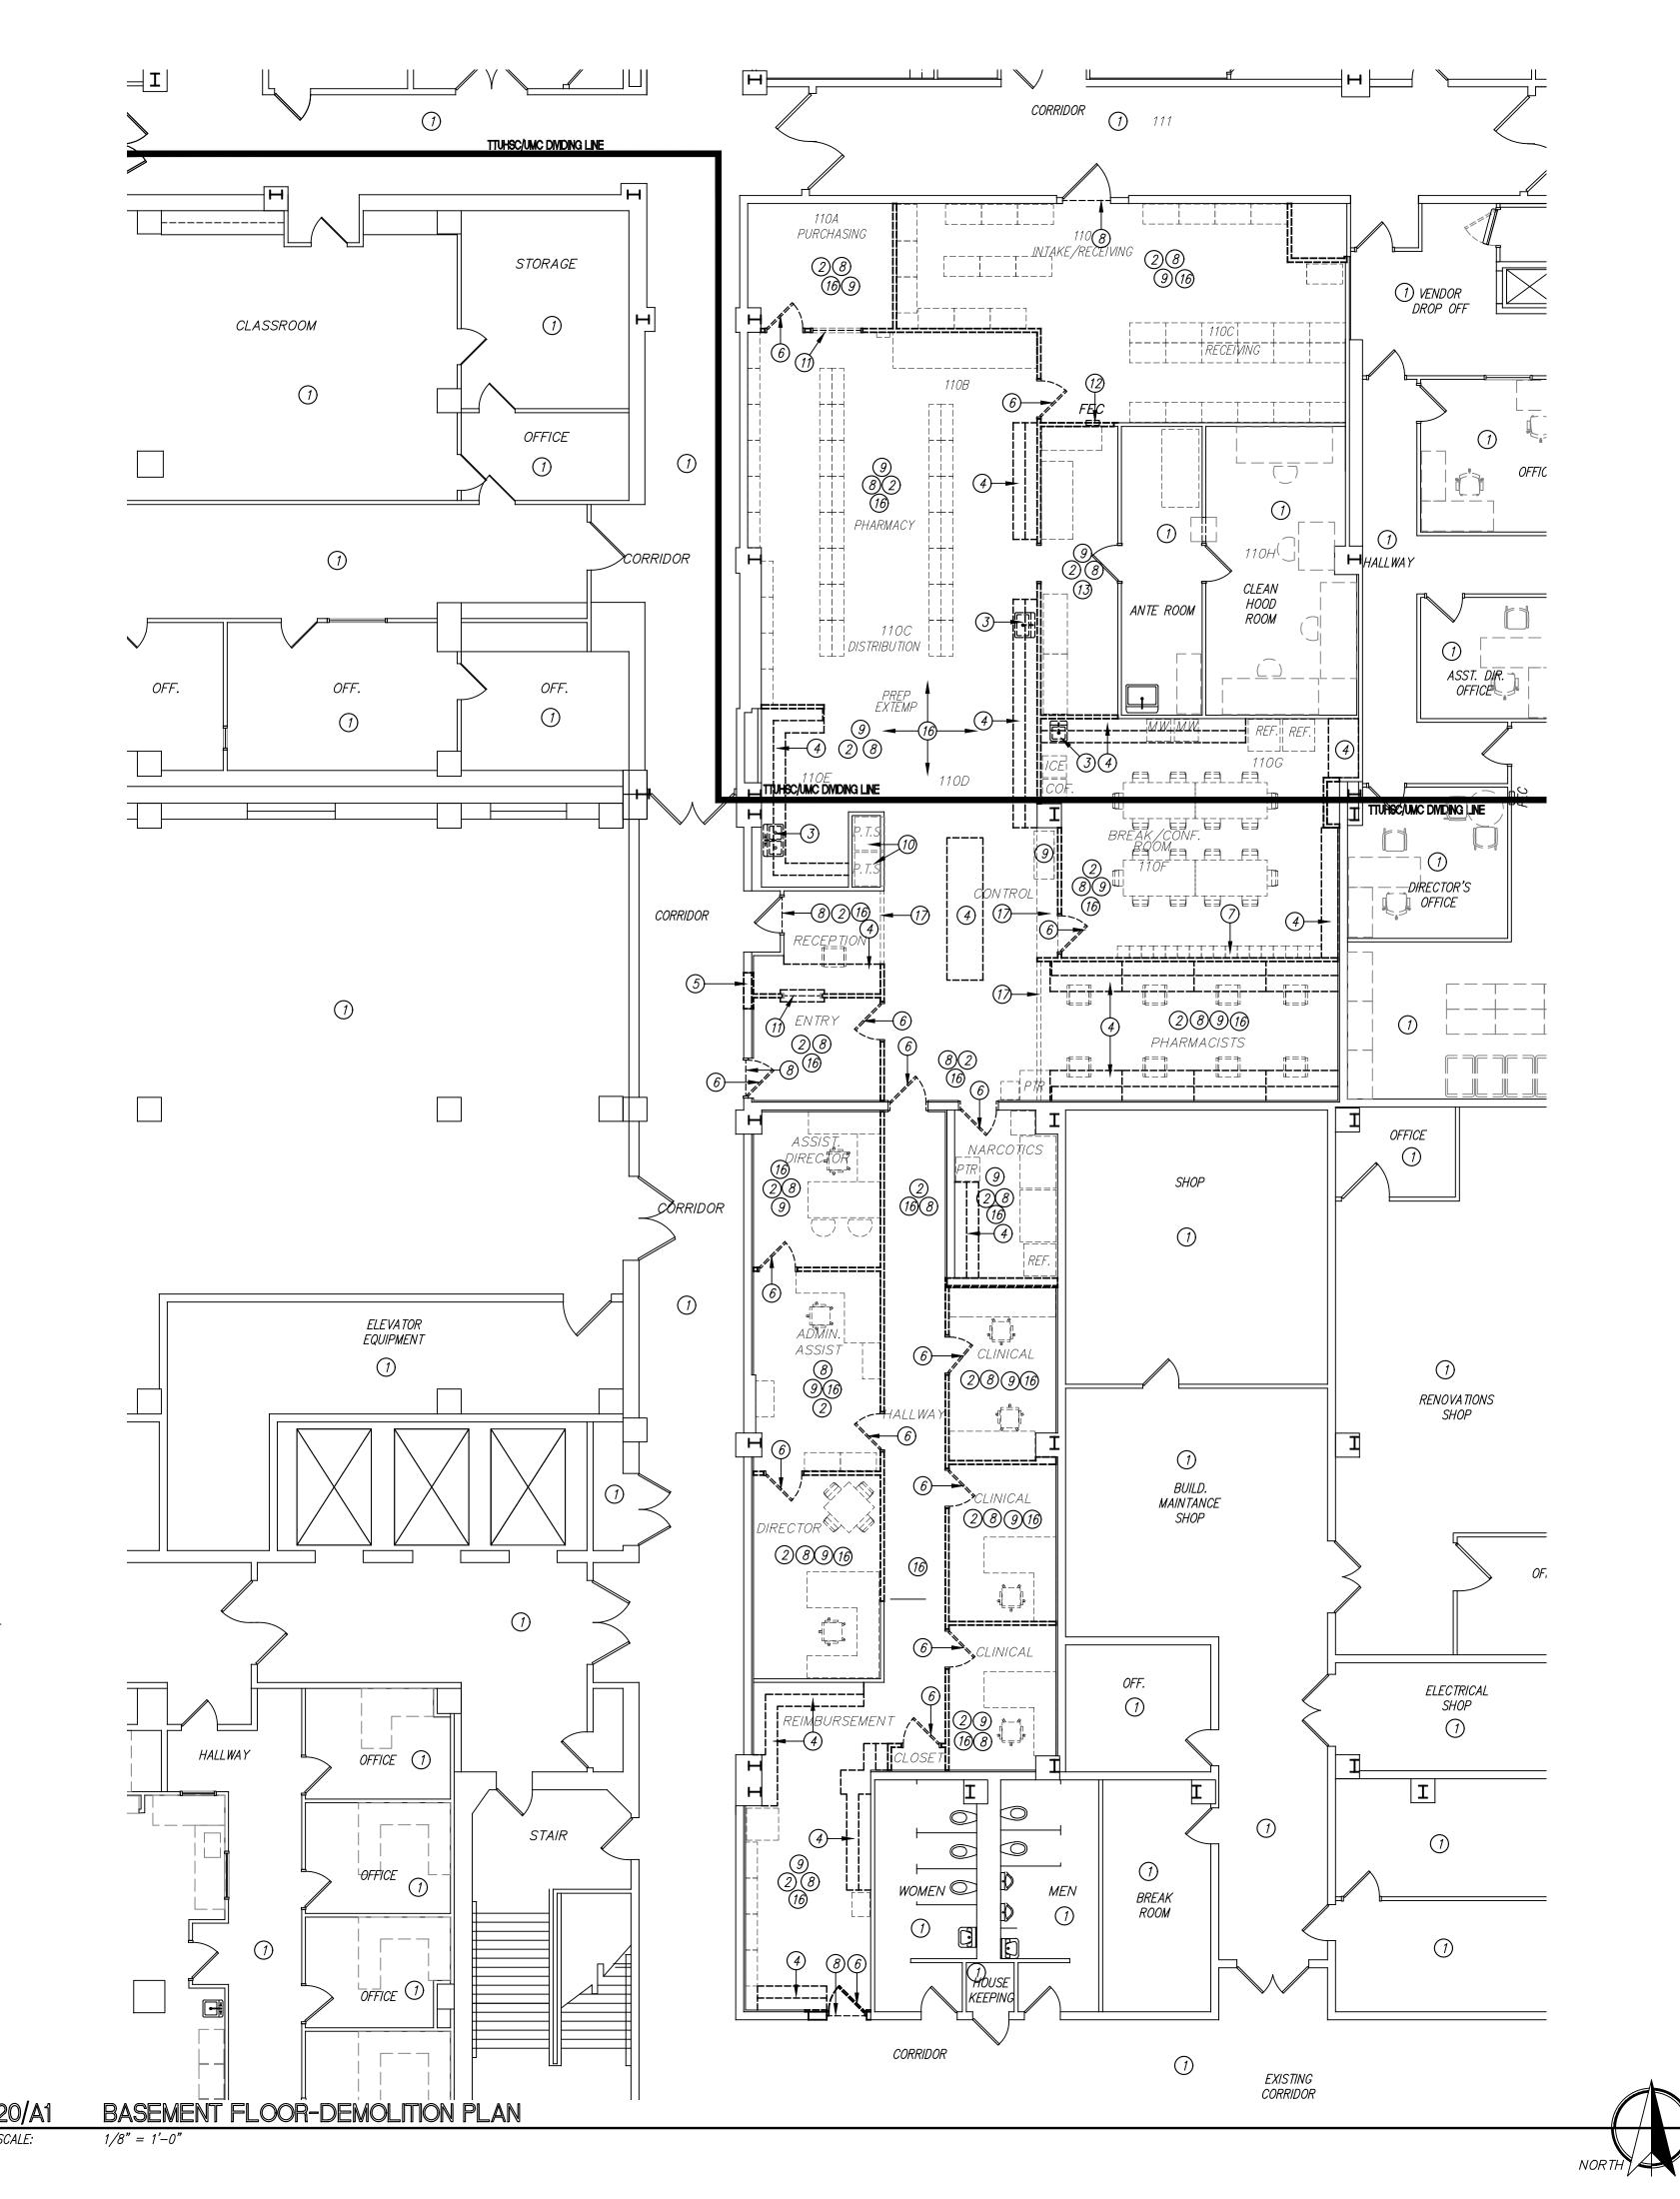




04/02/2025

SHEET NO.

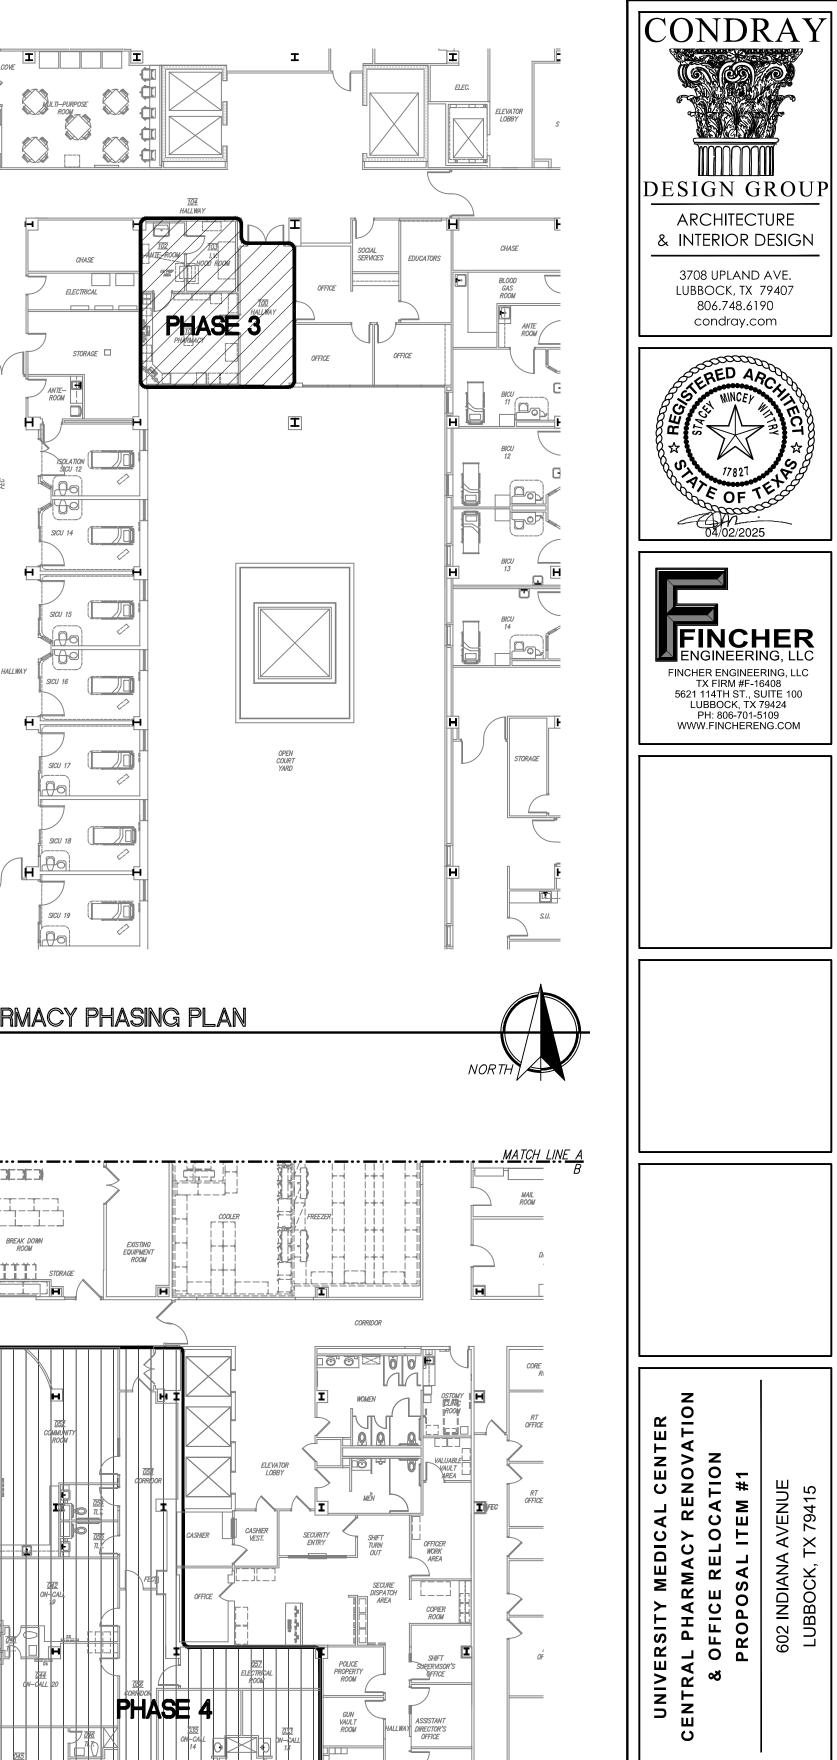CR3



DIAL YSIS

*MAINTENANCE* 

ROOM

28

COMM

SCALE:

1/8" = 1'-0"

TELEMETRY

STORAGE (1)

BASEMENT FLOOR-DEMOLITION PLAN

9(16)

1

= **|----**

**|======** 

9(16)

MECHANICAL

ELECTRICAL

CORRIDOR

# GENERAL NOTES

- 1). REFER TO MECHANICAL, PLUMBING AND ELECTRICAL SHEETS, WHERE APPLICABLE, FOR ADDITIONAL DEMOLITION INFORMATION.
- 2). ON ALL WALLS SCHEDULED TO REMAIN TO BE REWORKED OR RECEIVE NEW FINISH, CONTRACTOR SHALL REMOVE ANY EXISTING EQUIPMENT, DECORATIONS, DEVICES, ETC. AND SALVAGE FOR REINSTALLATION AS DIRECTED BY OWNER. CONTRACTOR IS TO PATCH BACK ANY HOLES OR ABANDONED ANCHORS AND RETEXTURE WALLS IF NECESSARY, AND PREP FOR NEW FINISH AS SCHEDULED.
- 3). NOTIFY ARCHITECT OF ANY DISCREPANCIES WITH EXISTING OR NEW CONDITIONS.
- 4). CONTRACTOR SHALL PATCH AND REPAIR WALLS, FLOOR, AND CEILINGS AT ALL INTERSECTIONS WHERE WALLS ARE REMOVED OR WHERE DEVICES, EQUIPMENT, ACCESSORIES, ETC. ARE REMOVED. PREP WALLS TO RECEIVE NEW FINISH. NEW CONSTRUCTION SHOULD MATCH ADJACENT FINISHES AND MATERIALS AND PROVIDE SMOOTH AND COMPLETE TRANSITION.
- 5). ALL ITEMS INDICATED TO BE SALVAGED ARE TO BE VERIFIED WITH THE OWNER. IF OWNER DECLINES SALVAGE, CONTRACTOR SHALL REMOVE ITEMS FROM THE SITE AND DISPOSE OF THEM PROPERLY.
- 6). ALL ABANDONED PIPING, CONDUIT, WIRING, ETC. IS TO BE REMOVED BACK TO THE SOURCE, I.E. FURTHER JOINT WHERE NOTHING ELSE IS SERVED OFF OF THE SAME FEED.
- 7). CONTRACTOR IS RESPONSIBLE FOR THE REMOVAL AND REINSTALLATION OF ANY PLUMBING FIXTURES, ELECTRICAL ITEMS, TOILET ACCESSORIES, WALL-HUNG EQUIPMENT, ETC. WHERE WALLS ARE TO RECEIVE NEW FINISHES. ALL ITEMS ARE TO BE REINSTALLED IN COMPLIANCE WITH T.A.S. REQUIREMENTS.
- 8). FOR ALL DOOR FRAMES IN SCOPE OF PROJECT, PREP AND PAINT. REFER TO FINISH SCHEDULE.
- 9). REMOVE/REPAIR ANY ABANDONED WALL ANCHORS OR HOLES FOR NEW FINISH.
- 10). PATCH BACK AND REPAIR ALL WALLS, CEILING AND FLOORS WHERE DAMAGED DUE TO FIXTURE OR DEVICE REMOVAL/RELOCATION. MATCH MATERIAL OR EXISTING SURROUNDING CONDITIONS.
- 11). ALL EXISTING FLOORING TO BE REMOVED AS REQUIRED TO ACCOMMODATE NEW WORK. REFER TO FINISH SCHEDULE.
- 12). REPAIR GRID AND REPLACE CEILING TILES WHERE WALLS, FIXTURES, OR DEVICES ARE REMOVED. REPLACE ALL DAMAGED CEILING TILES IN THE AREA OF WORK. GRID SECTIONS ARE TO BE REPLACED BACK TO NEAREST 4' SECTION AT A MINIMUM. NO SPLICES.
- 13). REPLACE DAMAGED CEILING GRID OR HARD CEILING WHERE WALLS ARE REMOVED. MATCH EXISTING.

# KEYED NOTES

DESIGNATED BY: -

- (1) NO WORK IN THIS AREA.
- (2) PREP ALL WALLS SCHEDULED TO REMAIN TO RECEIVE NEW PAINT. REMOVE ANY ABANDONED ANCHORS, REPAIR ANY GOUGES OR HOLES AND RE-TEXTURE WALLS AS REQUIRED TO MATCH EXISTING TEXTURED WALLS.
- 3 REMOVE EXISTING PLUMBING FIXTURE(S) AND ACCESSORIES. CAP AND TERMINATE. REFER TO PLUMBING FOR MORE INFORMATION.
- (4) REMOVE EXISTING MILLWORK IN ITS ENTIRETY.
- (5) REMOVE PORTION OF WALL TO ACCOMMODATE NEW WORK.
- 6 REMOVE EXISTING DOOR AND FRAME. SALVAGE FOR OWNER
- (7) REMOVE EXISTING METAL LOCKERS. SALVAGE FOR OWNER REUSE.
- (8) REMOVE ALL FLOORING AND WALL BASE IN THEIR ENTIRETY. PREP FLOOR FOR NEW FINISH.
- (9) COORDINATE REMOVAL OR RELOCATION OF EXISTING EQUIPMENT WITH OWNER. SALVAGE FOR OWNER REUSE.
- 10) PNEUMATIC TUBE STATION TO REMAIN. PROTECT DURING CONSTRUCTION.
- 11) REMOVE EXISTING WINDOW AND FRAME. SALVAGE FOR OWNER
- (12) REMOVE EXISTING FIRE EXTINGUISHER CABINET. SALVAGE FOR OWNER REUSE.
- (13) REMOVE PORTION OF HARD CEILING TO ACCOMMODATE NEW WORK.
- (14) EXISTING MILLWORK TO REMAIN. PROTECT DURING CONSTRUCTION.
- (15) REMOVE EXISTING GYPSUM BOARD FROM EXISTING WALL TO REMAIN. REPAIR WATER DAMAGE IN THIS AREA. PREP EXISTING STUDS FOR NEW GYPSUM BOARD AND NEW FINISH AS SCHEDULED.
- (16) REMOVE EXISTING CEILING TILES, GRID, LIGHT FIXTURES AND DEVICES TO ACCOMMODATE NEW WORK. REFER TO MPE FOR MORE
- REMOVE EXISTING FURRDOWN/HEADER TO ACCOMMODATE NEW
- (18) REMOVE EXISTING MED GASSES. PATCH AND REPAIR WALL. PREP WALL TO RECEIVE NEW PAINT.

# DEMOLITION PLAN LEGEND


EXISTING DOOR TO BE REMOVED

EXISTING DOOR TO REMAIN

===== EXISTING WALL TO BE REMOVED

EXISTING WALL TO REMAIN

FLOORING EXTENT

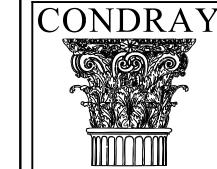


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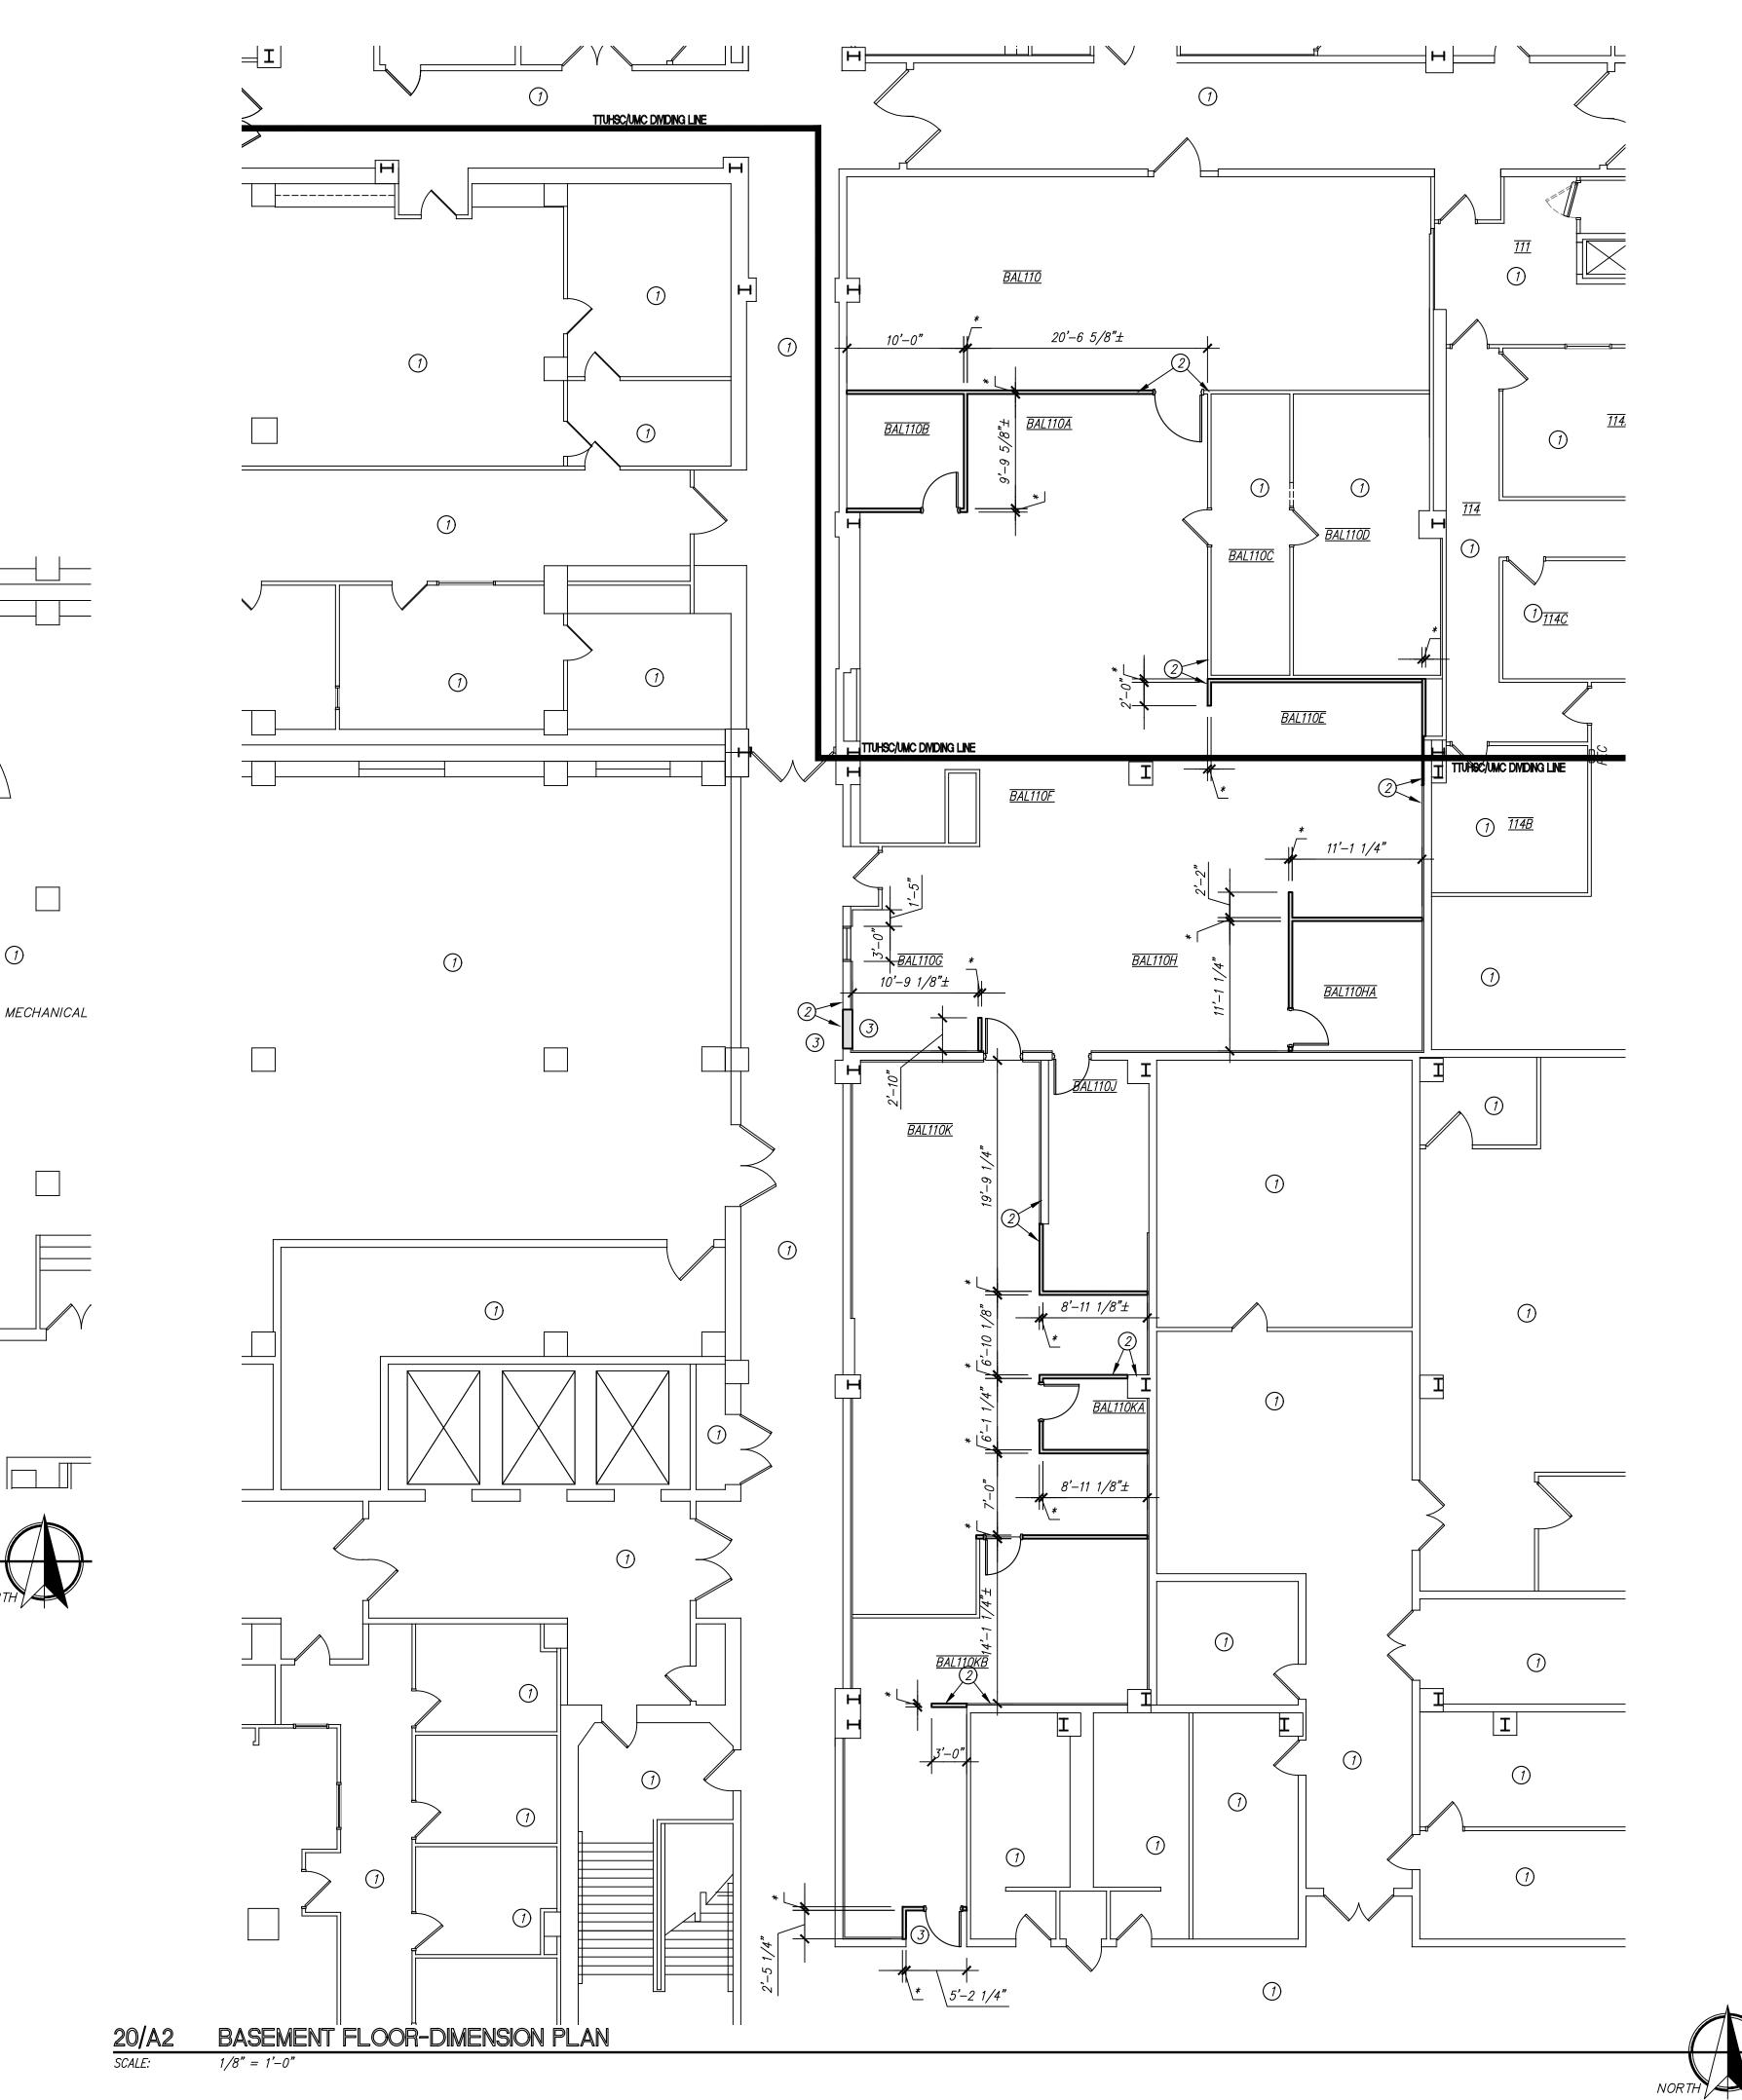


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SHEET NO.



<u>006</u>
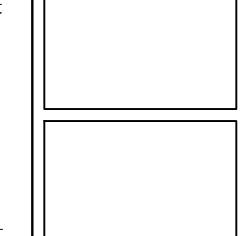
<u>008</u>

TELEMETRY STORAGE (1)

BASEMENT FLOOR-DIMENSION PLAN

COMM

ELECTRICAL (1)

CORRIDOR

<u>004</u>

<u>003</u>


# GENERAL NOTES


- 1). ALL DIMENSIONS ARE ACTUAL DIMENSIONS TO FACE OF METAL STUDS, OR FACE OF EXISTING WALL FINISH UNLESS NOTED OTHERWISE.
- 2). FIELD VERIFY ALL DIMENSIONS, NEW OR EXISTING, PRIOR TO CONSTRUCTION AND ADJUST WHERE REQUIRED TO PROVIDE A PROPER AND COMPLETE INSTALLATION. NOTIFY THE ARCHITECT OF ANY DISCREPANCIES WITH EXISTING OR NEW CONDITIONS.
- 3). CONTRACTOR SHALL COORDINATE ALL LAYOUT WORK WITH EQUIPMENT MANUFACTURER'S DIMENSIONAL REQUIREMENTS. THIS INCLUDES CONTRACTOR AND OWNER PROVIDED EQUIPMENT.
- 4). \* = 3.5/8" MTL. STUDS @ 16" O.C.
- 5). THE MECHANICAL, PLUMBING AND ELECTRICAL DRAWINGS ARE SUPPLEMENTARY TO THE ARCHITECTURAL DRAWINGS. SHOULD THERE BE A DISCREPANCY BETWEEN THE ARCHITECTURAL DRAWINGS AND THE CONSULTANT DRAWINGS, SUCH DISCREPANCY IS TO BE BROUGHT TO THE ATTENTION OF THE ARCHITECT AND THE CONTRACTOR SHALL RECEIVE INSTRUCTION PRIOR TO INSTALLATION OR PERFORMANCE OF SAID WORK. ANY WORK PERFORMED IN CONFLICT WITH THE DRAWINGS SHALL BE CORRECTED BY THE CONTRACTOR AT HIS OWN EXPENSE.
- 6). ALL CONSTRUCTION SHALL COMPLY WITH APPLICABLE ACCESSIBILITY CODE REQUIREMENTS. THE CONTRACTOR SHALL BE AWARE OF ALL DIMENSIONALLY CRITICAL AREAS AND COMPLY WITH APPLICABLE STANDARDS. IF THERE ARE ANY DISCREPANCIES, THESE ARE TO BE BROUGHT TO THE ARCHITECT'S ATTENTION IMMEDIATELY.
- 7). NEW CONSTRUCTION INTERSECTING WITH EXISTING CONDITIONS SHALL MATCH EXISTING ELEVATIONS AND PROVIDE A SMOOTH TRANSITION.



DESIGNATED BY:

- 1) NO WORK IN THIS AREA.
- (2) ALIGN FINISHES.
- 3 PROVIDE SMOOTH TRANSITION WHERE WALL OR DOOR WAS REMOVED. MATCH EXISTING.

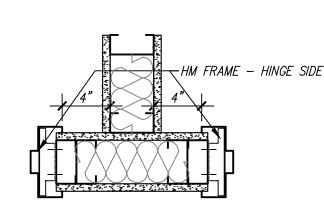

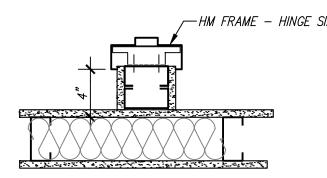

\*TYPICAL UNLESS DIMENSIONED OR INDICATED OTHERWISE ON THE PLANS

<u>04/A2</u> SCALE: TYPICAL FRAME BACKSET




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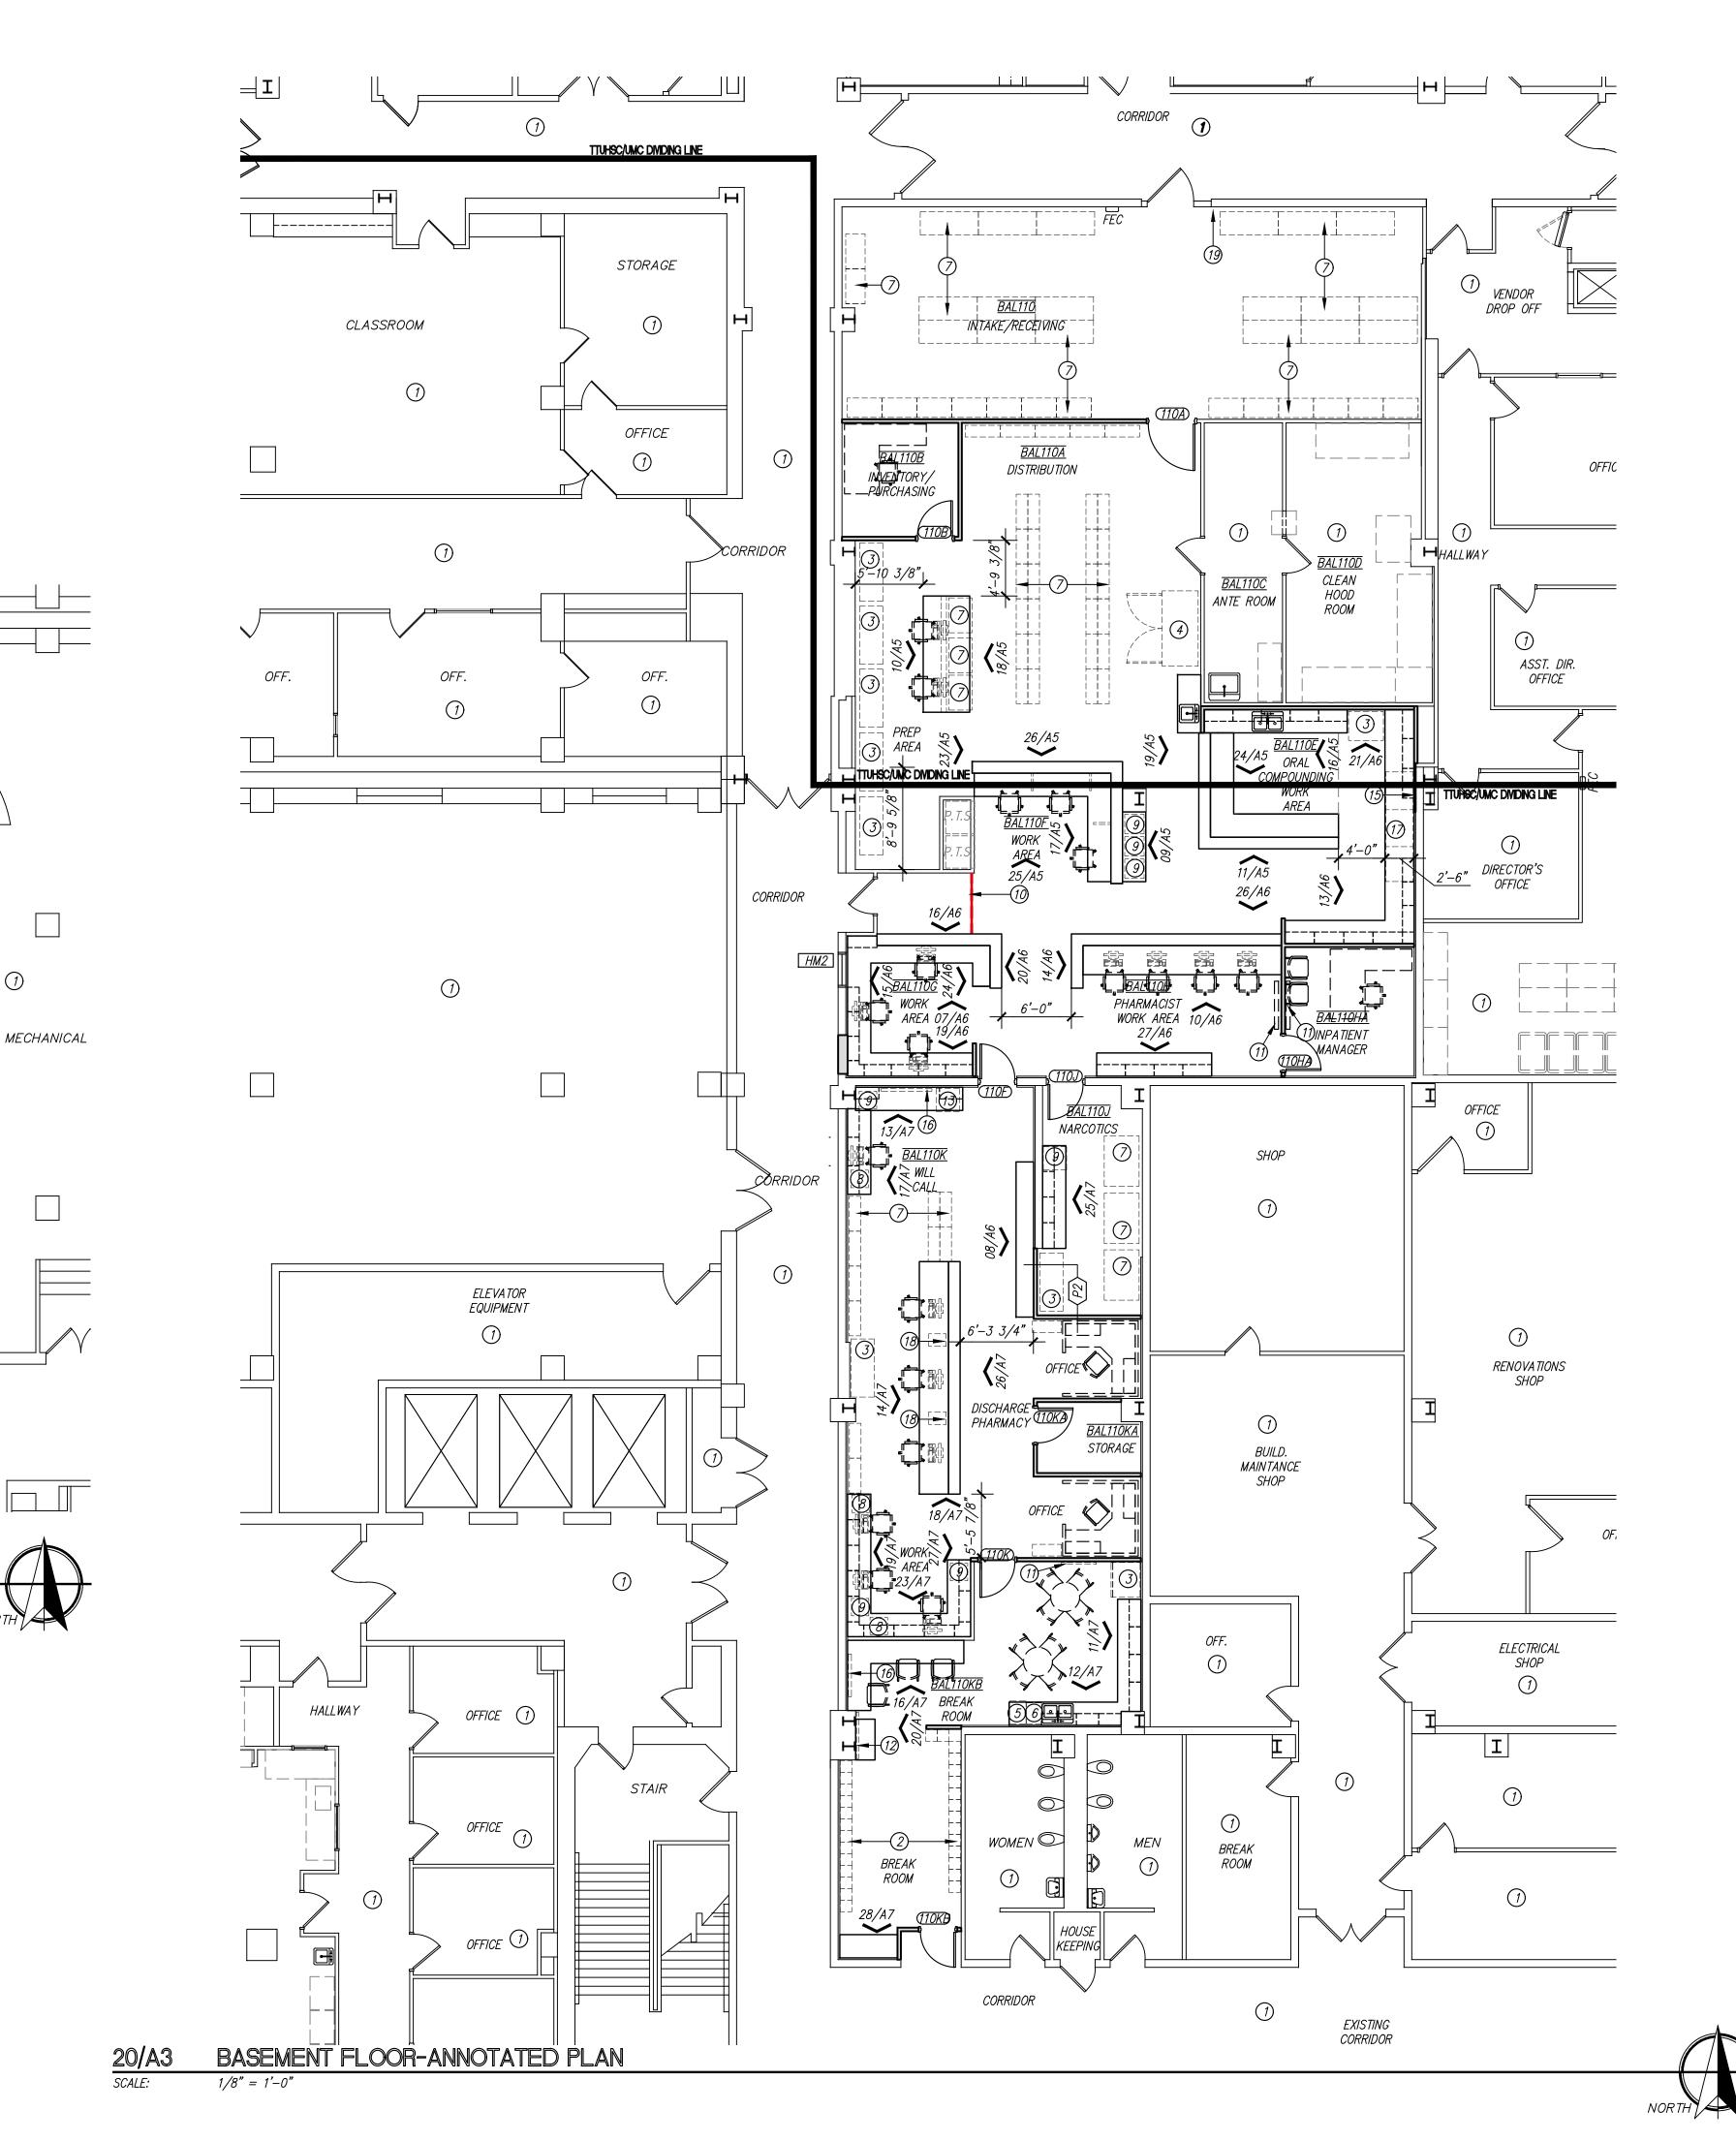






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04/02/2025 SHEET NO.

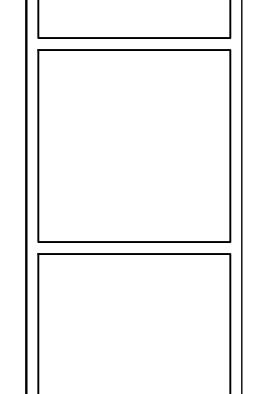

DIAL YSIS

PHARMACY

TELEMETRY STORAGE (1)

BASEMENT FLOOR-ANNOTATED PLAN

COMM

1/8" = 1'-0"

<u>OO1</u> ENTRY

CORRIDOR

1

DIRECTOR

OFFICE

<u>003</u> – *-PFFICE* 

CONFERÊNICE

ELECTRICAL

# GENERAL NOTES

- 1). ON ALL WALLS SCHEDULED TO REMAIN. PATCH ANY EXISTING HOLES, CRACKS, OR OTHERWISE DAMAGED AREAS AND RE-TEXTURE AND PAINT AS SCHEDULED.
- 2). THE MECHANICAL, PLUMBING AND ELECTRICAL DRAWINGS ARE SUPPLEMENTARY TO THE ARCHITECTURAL DRAWINGS. SHOULD THERE BE A DISCREPANCY BETWEEN THE ARCHITECTURAL DRAWINGS AND THE CONSULTANT DRAWINGS, SUCH DISCREPANCY IS TO BE BROUGHT TO THE ATTENTION OF THE ARCHITECT AND THE CONTRACTOR SHALL RECEIVE INSTRUCTION PRIOR TO INSTALLATION OR PERFORMANCE OF SAID WORK. ANY WORK PERFORMED IN CONFLICT WITH THE DRAWINGS SHALL BE CORRECTED BY THE CONTRACTOR AT HIS OWN EXPENSE.
- 3). REFER TO PROJECT MANUAL FOR ROOM FINISH SCHEDULE.
- 4). ALL NEW WALLS TO RECEIVE FULL BATT INSULATION FROM FLOOR TO THE FULL HEIGHT OF THE WALL, INCLUDING ABOVE CEILING.
- 5). ALL WALLS ARE TO BE PARTITION TYPE 'P1' UNLESS NOTED
- 6). ANY CORING THAT IS NECESSARY FOR THE INSTALLATION OF PLUMBING LINES, CONDUITS, ETC. IS TO BE SCHEDULED WITH THE
- 7). AT ALL NEW FLOOR DRAIN LOCATIONS, THE SLAB IS TO BE RECESSED AND SLOPED FOR POSITIVE DRAINAGE. UNLESS NOTED OTHERWISE, SLOPE IS TO BE 1/8":1'-0" WITH 1/2" OVERALL RECESS. EXISTING SLABS ARE TO BE CHIPPED OUT TO ACCOMMODATE.
- 8). CONTRACTOR SHALL COORDINATE ALL WORK WITH EQUIPMENT MANUFACTURER'S REQUIREMENTS.
- 9). FURNITURE IS SHOWN FOR REFERENCE ONLY.

OWNER IN ADVANCE.

10). INSTALL NEW BASE AT NEW AND EXISTING WALL CONSTRUCTION WITHIN SCOPE OF WORK. PROVIDE SMOOTH TRANSITION BY RETURNING BASE TO CORNER.

# KEYED NOTES

- 1) NO WORK IN THIS AREA.
- (2) NEW THREE-TIER LOCKERS AS SPECIFIED.
- (3) REFRIGERATOR. OWNER FURNISHED, CONTRACTOR INSTALLED.
- (4) FREEZER. OWNER FURNISHED, CONTRACTOR INSTALLED.
- (5) ICE MAKER. OWNER FURNISHED, CONTRACTOR INSTALLED.
- (6) COFFEE MAKER. OWNER FURNISHED, CONTRACTOR INSTALLED.
- (7) EQUIPMENT. OWNER FURNISHED, OWNER INSTALLED.
- (8) LABEL MAKER. OWNER FURNISHED, OWNER INSTALLED.
- (9) PRINTER. OWNER FURNISHED, OWNER INSTALLED.
- 10) RED LINE FLOOR.
- 11) BULLETIN BOARD. OWNER FURNISHED, CONTRACTOR INSTALLED. COORDINATE EXACT LOCATION WITH OWNER.
- (12) COAT HOOKS. OWNER FURNISHED, CONTRACTOR INSTALLED. COORDINATE EXACT LOCATION WITH OWNER.
- (13) POINT OF SALE REGISTER. OWNER FURNISHED, OWNER INSTALLED.
- (14) NEW GYPSUM BOARD INSTALLED ON EXISTING METAL STUDS.
- REFER TO FINISH SCHEDULE FOR NEW FINISH.
- (15) INSTALL NEW GYPSUM BOARD AND FRAME AS NEEDED TO ALIGN WITH ADJACENT WALLS. REFER TO FINISH SCHEDULE FOR NEW
- 16) WALL MOUNTED FLAT SCREEN T.V. OWNER FURNISHED, CONTRACTOR INSTALLED. CONTRACTOR TO INSTALL BLOCKING. COORDINATE EXACT LOCATION WITH OWNER.
- (17) UNIT DOSE PACKAGER. OWNER FURNISHED, OWNER INSTALLED.
- 18) ABOVE COUNTER EYECON MACHINE. OWNER FURNISHED, OWNER
- (19) NEW SURFACE MOUNTED FIRE EXTINGUISHER CABINET.

# FLOOR PLAN LEGEND

EXISTING WALL TO REMAIN

NEW STUD WALL

EXISTING DOOR TO REMAIN - IN AREA OF WORK, REPAINT FRAME TO MATCH NEW FRAMES.

NEW DOOR - REFER TO DOOR SCHEDULE

WINDOW DESIGNATION — REFER TO FRAME SCHEDULE




DESIGN GROU ARCHITECTURE & INTERIOR DESIGN



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SHEET NO.



- 1). REPAIR GRID AND REPLACE CEILING TILES WHERE WALLS, FIXTURES, OR DEVICES ARE REMOVED. REPLACE ALL DAMAGED CEILING TILES IN THE AREA OF WORK. GRID SECTIONS ARE TO BE REPLACED BACK TO NEAREST 4' SECTION AT A MINIMUM. NO SPLICES.
- 2). WHERE APPLICABLE, REWORK FIRE SPRINKLERS IN ACCORDANCE WITH NFPA 13 AS REQUIRED TO ACCOMMODATE NEW WORK.
- 3). COORDINATE LOCATION OF LIGHT FIXTURES AND HVAC GRILLES WITH CEILING GRID. NOTIFY ARCHITECT OF ANY DISCREPANCIES. IF LAYOUT OR QUANTITIES DIFFER FROM MPE SHEETS AND DISCREPANCIES ARE NOT ADDRESSED PRIOR TO BID, CONTRACTOR SHALL PROVIDE FIXTURES TO COVER THE LARGER QUANTITIES INDICATED.
- 4). EXCEPT FOR CEILING TILES HOUSING DEVICES, DO NOT INSTALL ANY CEILING TILES IN GRID UNTIL AFTER PRE-FINAL INSPECTION HAS BEEN PERFORMED AND DEFICIENCIES CERTIFIED AS CORRECTED.
- 5). INSTALL 3 1/2" SOUND BATT INSULATION CONTINUOUSLY ABOVE ALL CEILINGS IN AREA OF WORK, INCLUDING EXISTING CEILINGS WHERE SIMILAR SOUND BATTS DO NOT EXIST.
- 6). REMOVE AND REPLACE ANY EXISTING CEILING TILE AND GRID IN AREAS TO REMAIN AS EXISTING WHERE NECESSARY TO ACCOMMODATE ABOVE CEILING WORK.
- 7). CLEAN ALL HVAC GRILLS AND LIGHT FIXTURE LENSES IN AREA OF WORK, NEW AND EXISTING.
- 8). ALL CEILINGS TO BE INSTALLED AT 9'-0" A.F.F. UNLESS NOTED OTHERWISE.
- 9). REFER TO MECHANICAL, ELECTRICAL AND PLUMBING DRAWINGS FOR ADDITIONAL CEILING—MOUNTED ITEMS.
- 10). ALL CEILING MOUNTED DEVICES AND FIXTURES INDICATED ON THIS PLAN ARE SHOWN FOR LOCATION AND COORDINATION ONLY. REFER TO MECHANICAL AND ELECTRICAL SHEETS FOR MORE INFORMATION IF QUANTITIES ARE INCONSISTENT THE GREATER QUANTITY SHALL CONTROL. CONTACT ARCHITECT FOR CLARIFICATION ON LOCATIONS.
- 11). FIRE SPRINKLER SYSTEM IS TO BE REWORKED TO PROVIDE COMPLETE COVERAGE FOR ALL AREAS. CEILING GRID AND TILE TO BE REPLACED AS NEEDED TO ACCOMMODATE THIS WORK.
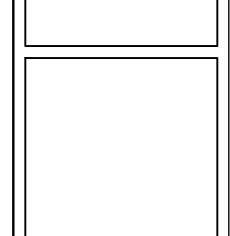
# **KEYED NOTES**

DESIGNATED BY: -


- 1) NO WORK IN THIS AREA.
- ② UNDERCABINET LIGHT FIXTURE. REFER TO ELECTRICAL FOR MORE INFORMATION.
- 3 TIE IN NEW GRID WITH EXISTING GRID TO CREATE SMOOTH TRANSITION.

# CEILING PLAN LEGEND

2x4 LIGHT FIXTURE — REFER TO ELECTRICAL SHEETS SUPPLY GRILLE - REFER TO MECHANICAL SHEETS



RETURN AIR GRILLE - REFER TO MECHANICAL SHEETS

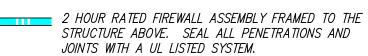


JOINTS WITH A UL LISTED SYSTEM. 1 HOUR RATED FIREWALL ASSEMBLY FRAMED TO THE STRUCTURE ABOVE. SEAL ALL PENETRATIONS AND JOINTS WITH A UL LISTED SYSTEM.

NON-RATED SMOKE PARTITION WALL PARTITION THAT IS NOT FIRE RATED AND DOES NOT EXTEND TO STRUCTURAL DECK ABOVE. WALL MAY TERMINATE 6" ABOVE CEILING. MUST PREVENT PASSAGE OF SMOKE.




DESIGN GROU ARCHITECTURE & INTERIOR DESIGN

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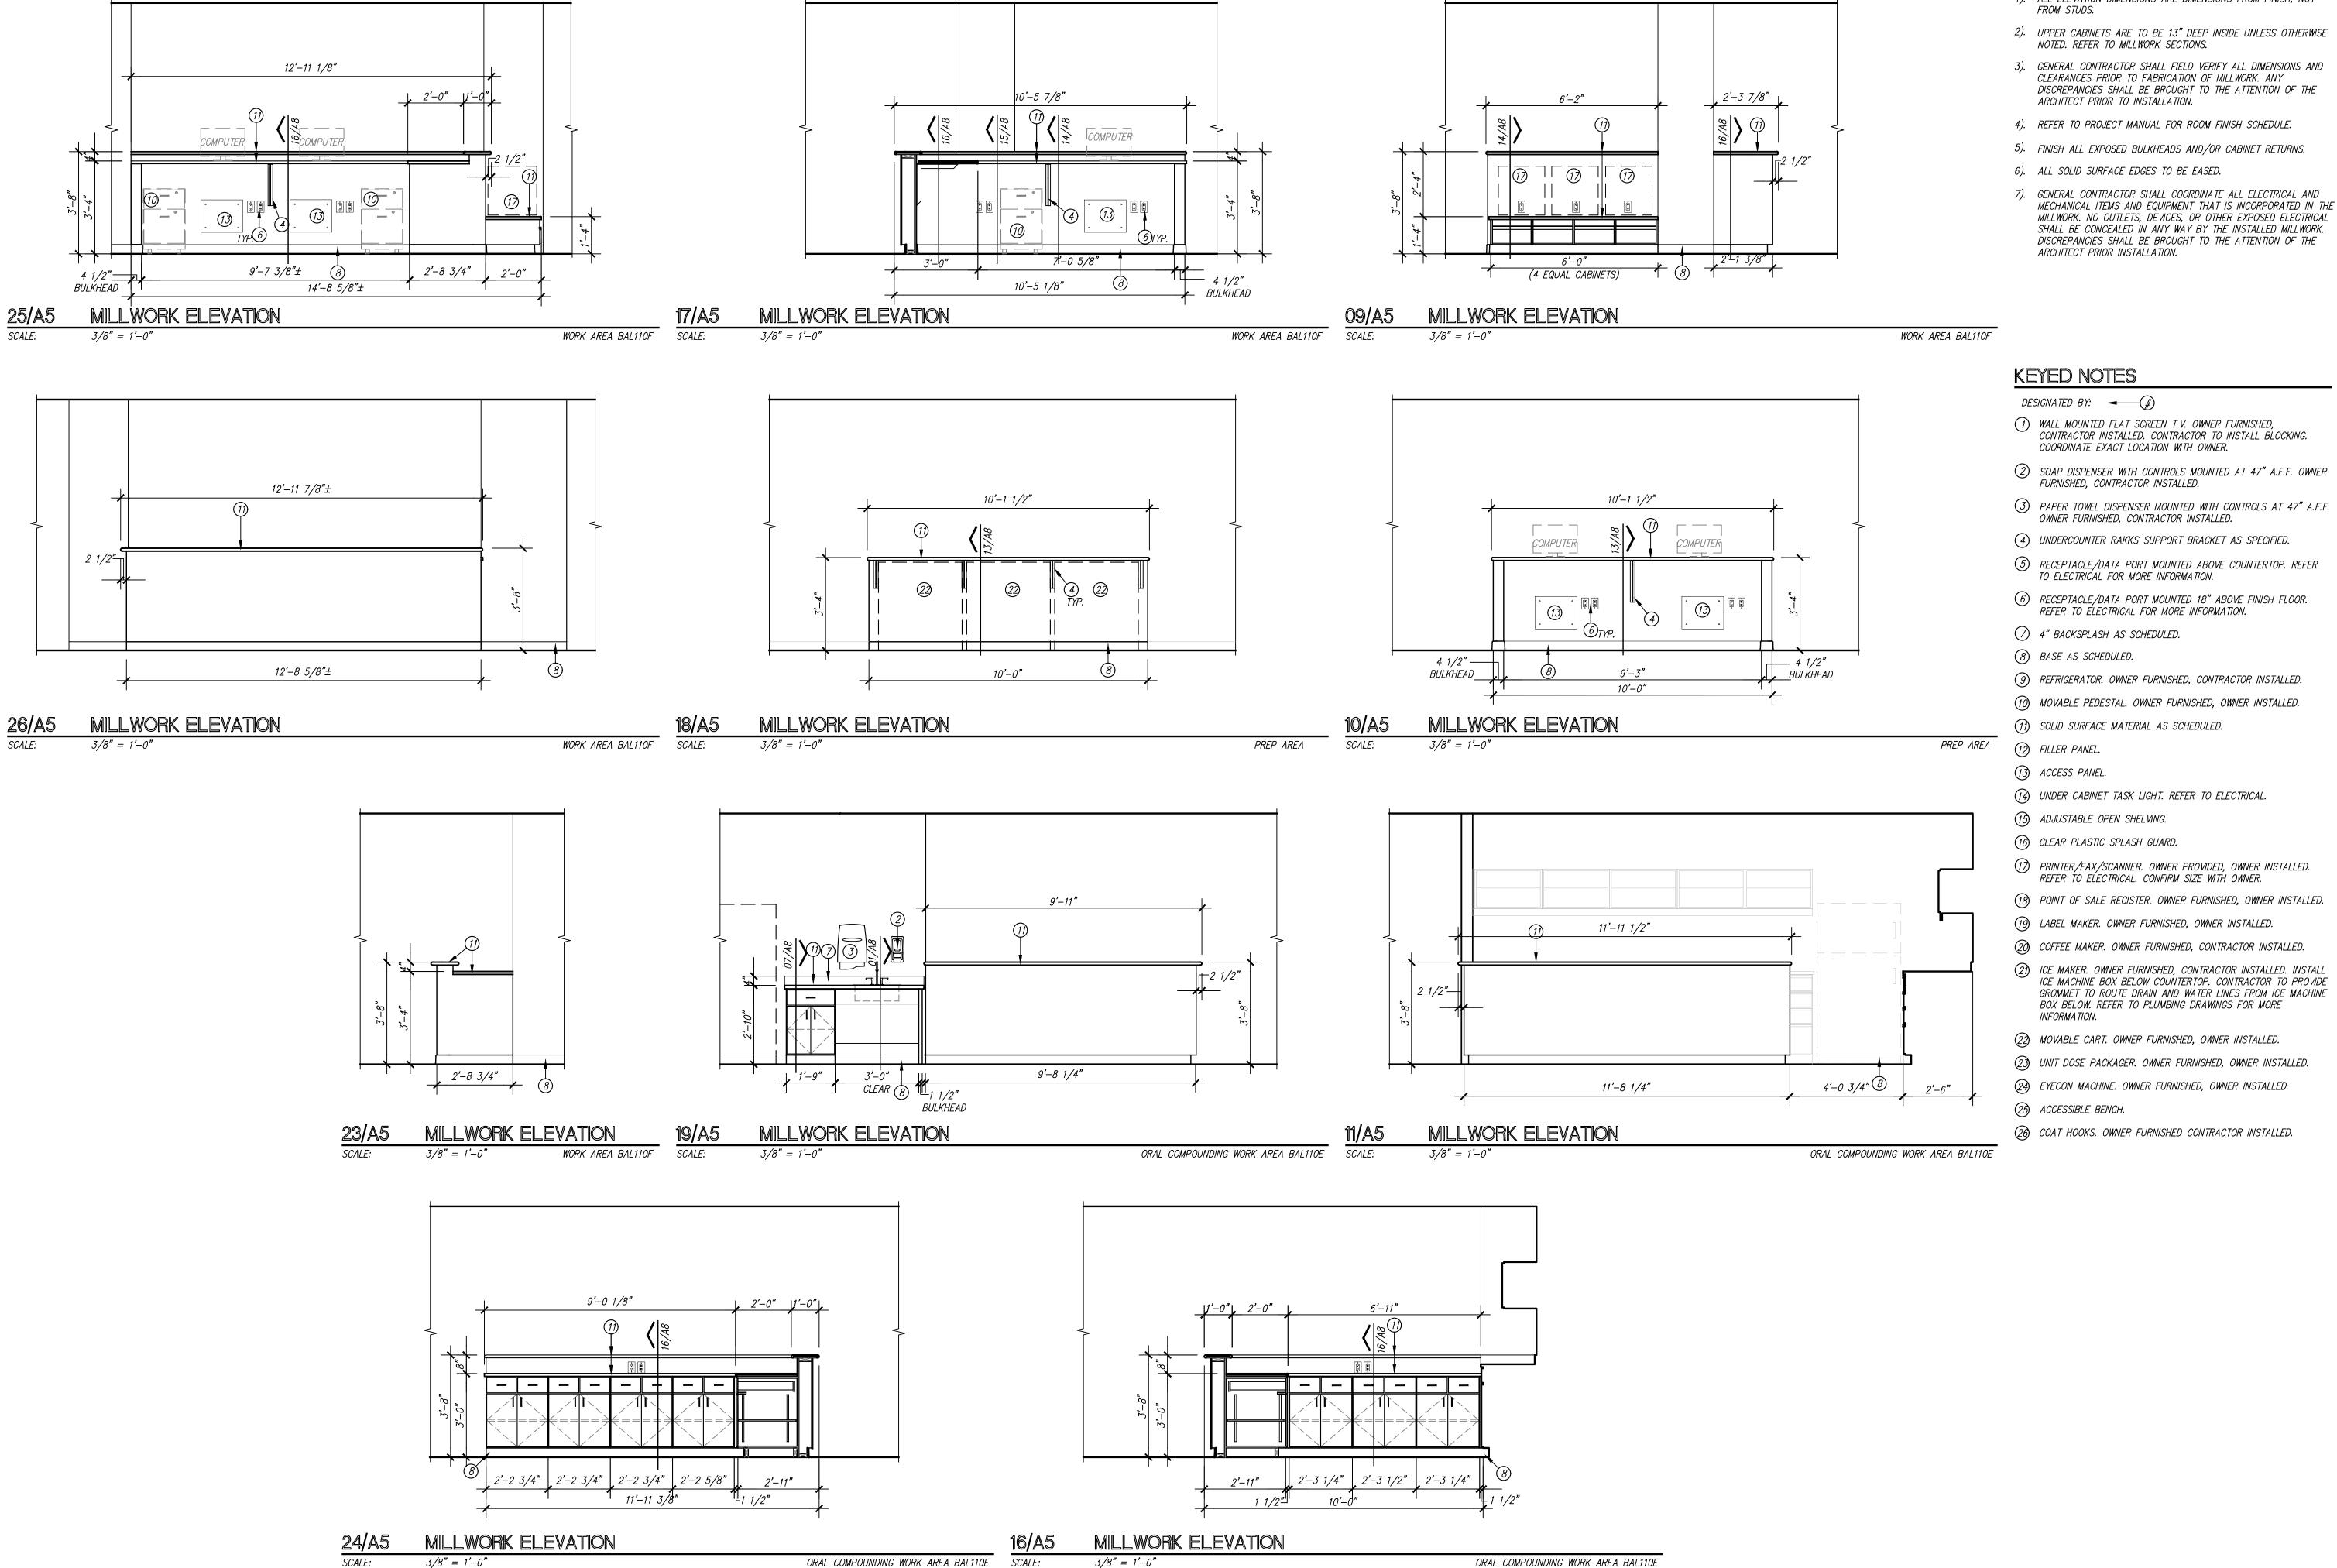


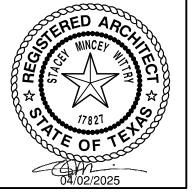

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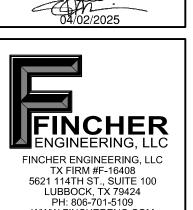


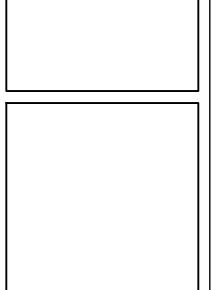- 1). ALL ELEVATION DIMENSIONS ARE DIMENSIONS FROM FINISH, NOT
- 2). UPPER CABINETS ARE TO BE 13" DEEP INSIDE UNLESS OTHERWISE NOTED. REFER TO MILLWORK SECTIONS.
- 3). GENERAL CONTRACTOR SHALL FIELD VERIFY ALL DIMENSIONS AND CLEARANCES PRIOR TO FABRICATION OF MILLWORK. ANY DISCREPANCIES SHALL BE BROUGHT TO THE ATTENTION OF THE ARCHITECT PRIOR TO INSTALLATION.
- 4). REFER TO PROJECT MANUAL FOR ROOM FINISH SCHEDULE.
- 5). FINISH ALL EXPOSED BULKHEADS AND/OR CABINET RETURNS.
- 6). ALL SOLID SURFACE EDGES TO BE EASED.
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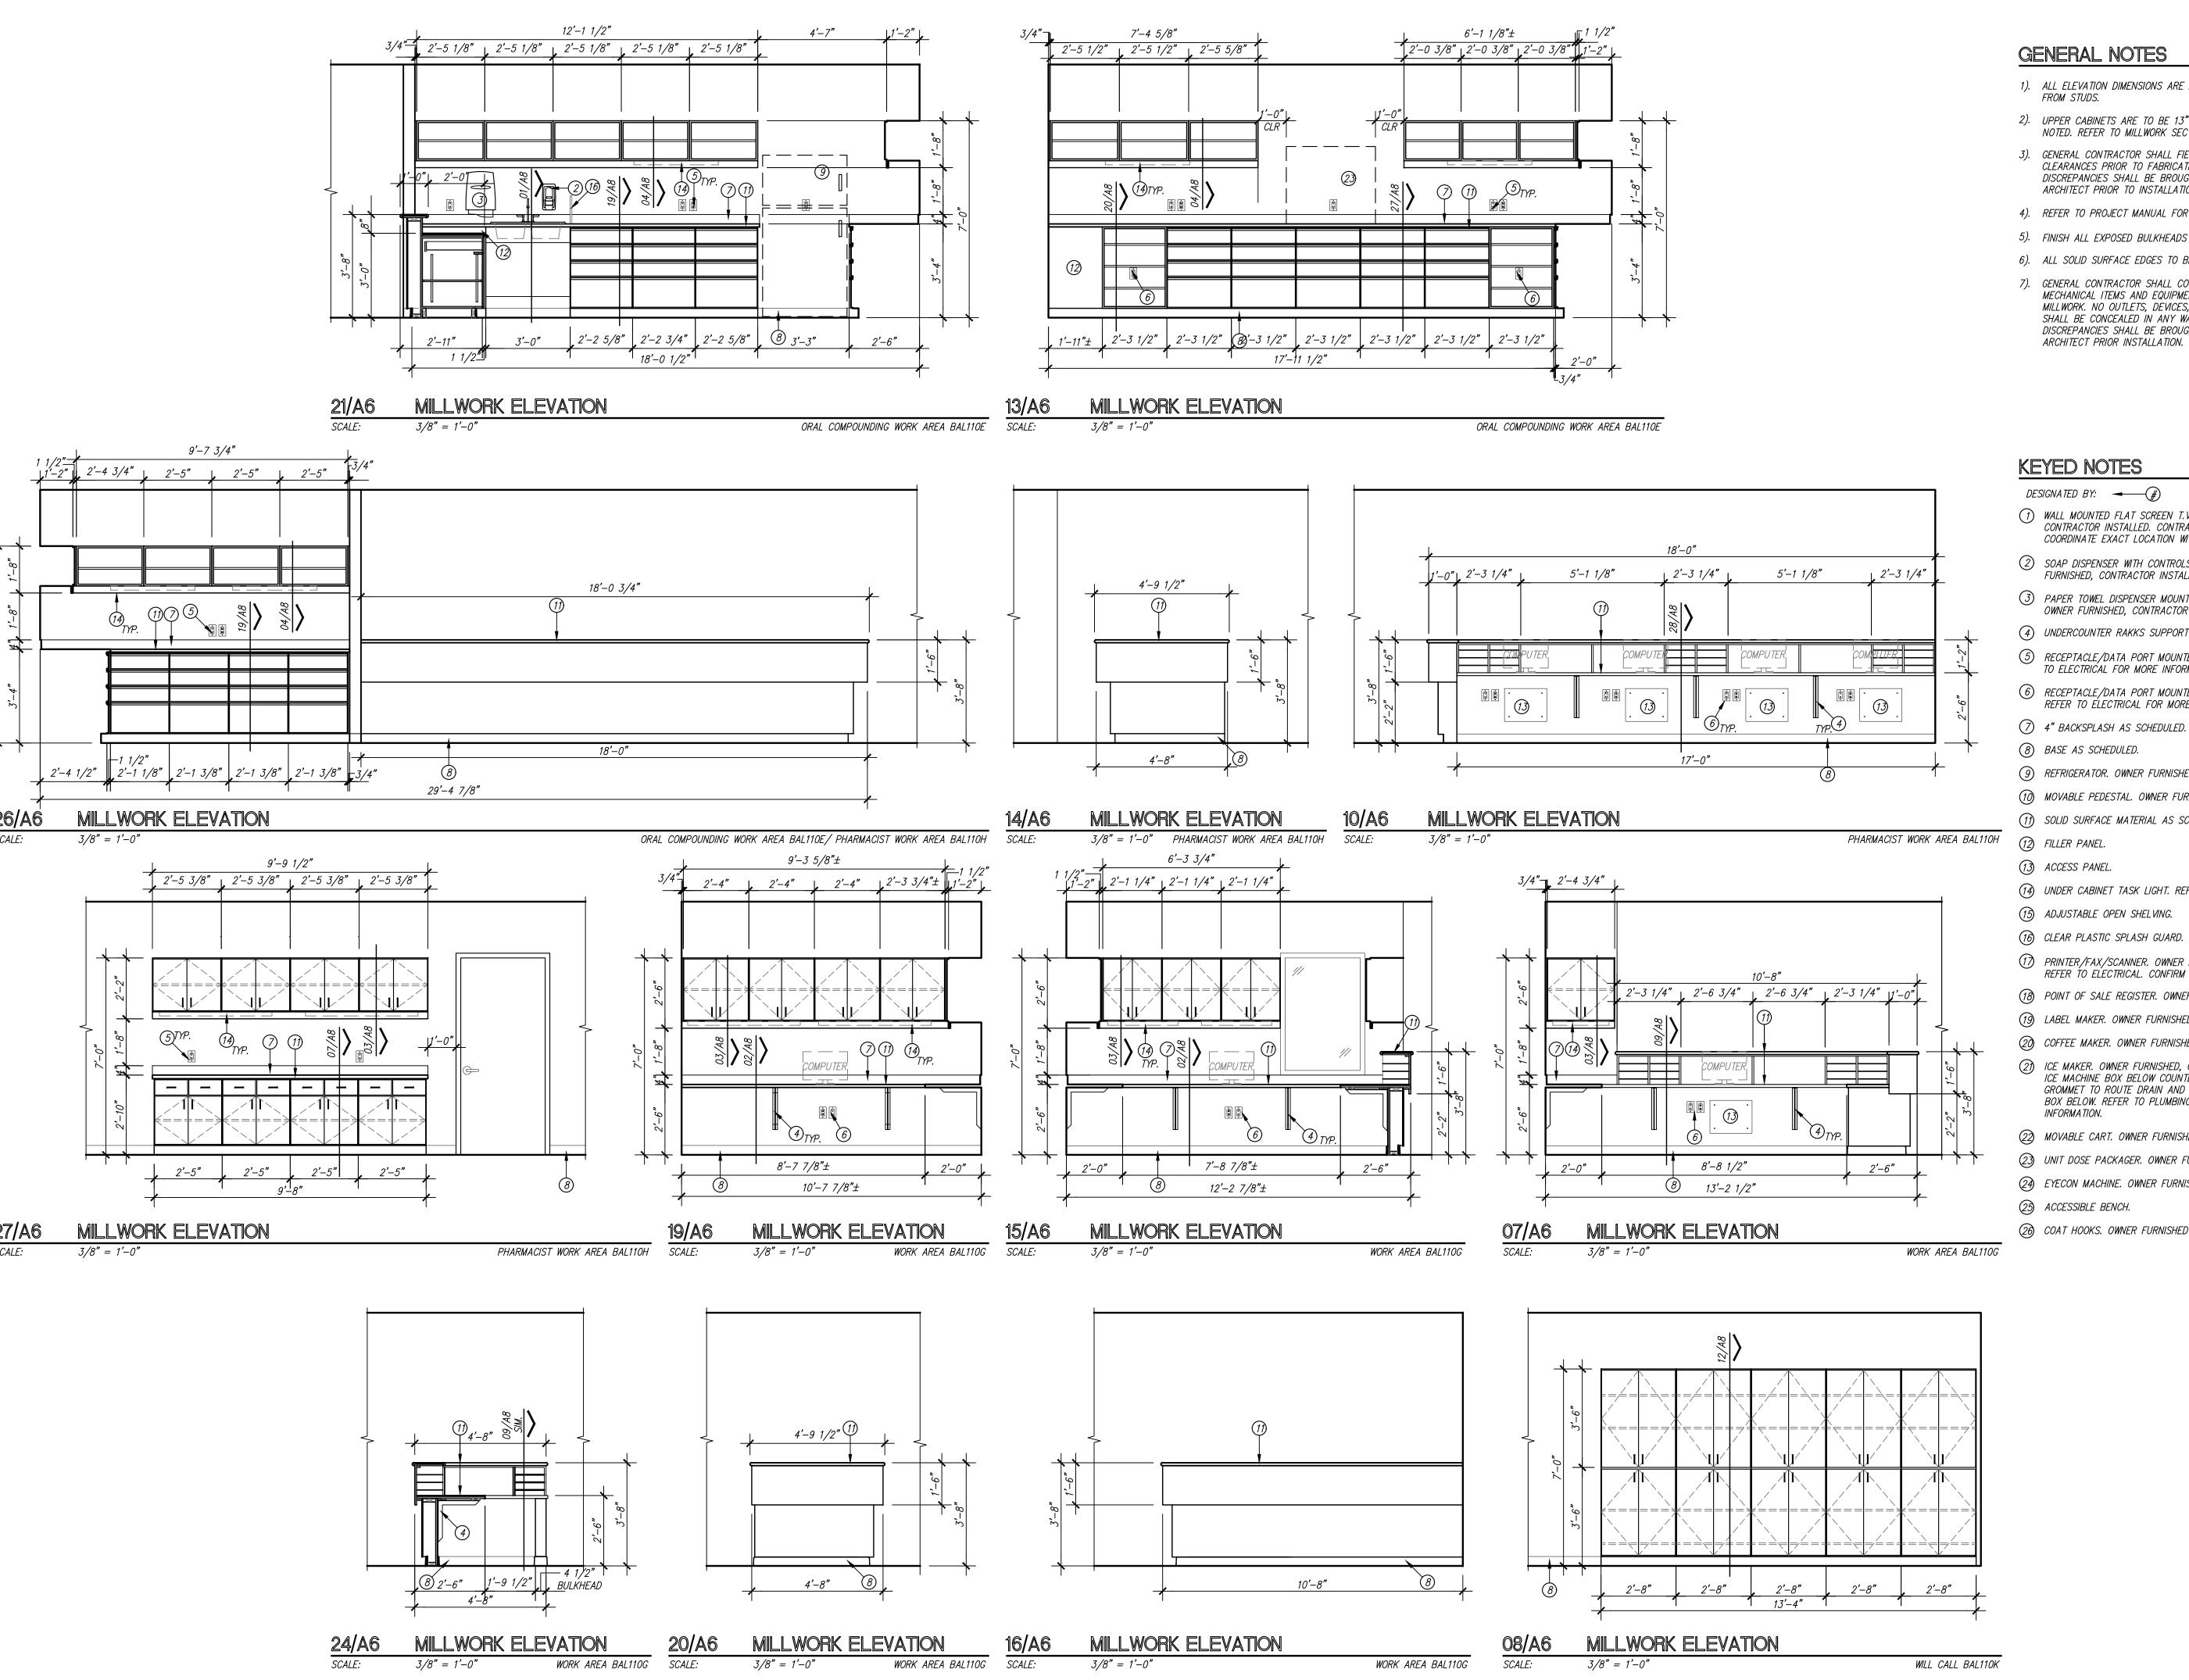
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CENTRAL PHARMACY RENOVATION
& OFFICE RELOCATION
PROPOSAL ITEM #1

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**CONDRAY** 



**FINCHER** 


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# **KEYED NOTES**


DESIGNATED BY:

- (1) WALL MOUNTED FLAT SCREEN T.V. OWNER FURNISHED, CONTRACTOR INSTALLED. CONTRACTOR TO INSTALL BLOCKING. COORDINATE EXACT LOCATION WITH OWNER.
- 2 SOAP DISPENSER WITH CONTROLS MOUNTED AT 47" A.F.F. OWNER FURNISHED, CONTRACTOR INSTALLED.
- (3) PAPER TOWEL DISPENSER MOUNTED WITH CONTROLS AT 47" A.F.F. OWNER FURNISHED, CONTRACTOR INSTALLED.
- (4) UNDERCOUNTER RAKKS SUPPORT BRACKET AS SPECIFIED.
- 5 RECEPTACLE/DATA PORT MOUNTED ABOVE COUNTERTOP. REFER TO ELECTRICAL FOR MORE INFORMATION.
- (6) RECEPTACLE/DATA PORT MOUNTED 18" ABOVE FINISH FLOOR. REFER TO ÉLECTRICAL FOR MORE INFORMATION.
- (7) 4" BACKSPLASH AS SCHEDULED.
- (8) BASE AS SCHEDULED.
- (9) REFRIGERATOR. OWNER FURNISHED, CONTRACTOR INSTALLED.
- (10) MOVABLE PEDESTAL. OWNER FURNISHED, OWNER INSTALLED.
- (11) SOLID SURFACE MATERIAL AS SCHEDULED.
- (12) FILLER PANEL.
- (13) ACCESS PANEL.
- 14) UNDER CABINET TASK LIGHT. REFER TO ELECTRICAL.
- (15) ADJUSTABLE OPEN SHELVING.
- (16) CLEAR PLASTIC SPLASH GUARD.
- (17) PRINTER/FAX/SCANNER. OWNER PROVIDED, OWNER INSTALLED. REFER TO ELECTRICAL. CONFIRM SIZE WITH OWNER.
- (18) POINT OF SALE REGISTER. OWNER FURNISHED, OWNER INSTALLED.
- (19) LABEL MAKER. OWNER FURNISHED, OWNER INSTALLED.
- (20) COFFEE MAKER. OWNER FURNISHED, CONTRACTOR INSTALLED.
- (21) ICE MAKER. OWNER FURNISHED, CONTRACTOR INSTALLED. INSTALL ICE MACHINE BOX BELOW COUNTERTOP. CONTRACTOR TO PROVIDE GROMMET TO ROUTE DRAIN AND WATER LINES FROM ICE MACHINE BOX BELOW. REFER TO PLUMBING DRAWINGS FOR MORE
- (22) MOVABLE CART. OWNER FURNISHED, OWNER INSTALLED.
- (23) UNIT DOSE PACKAGER. OWNER FURNISHED, OWNER INSTALLED.
- (24) EYECON MACHINE. OWNER FURNISHED, OWNER INSTALLED.
- (25) ACCESSIBLE BENCH.
- (26) COAT HOOKS. OWNER FURNISHED CONTRACTOR INSTALLED.



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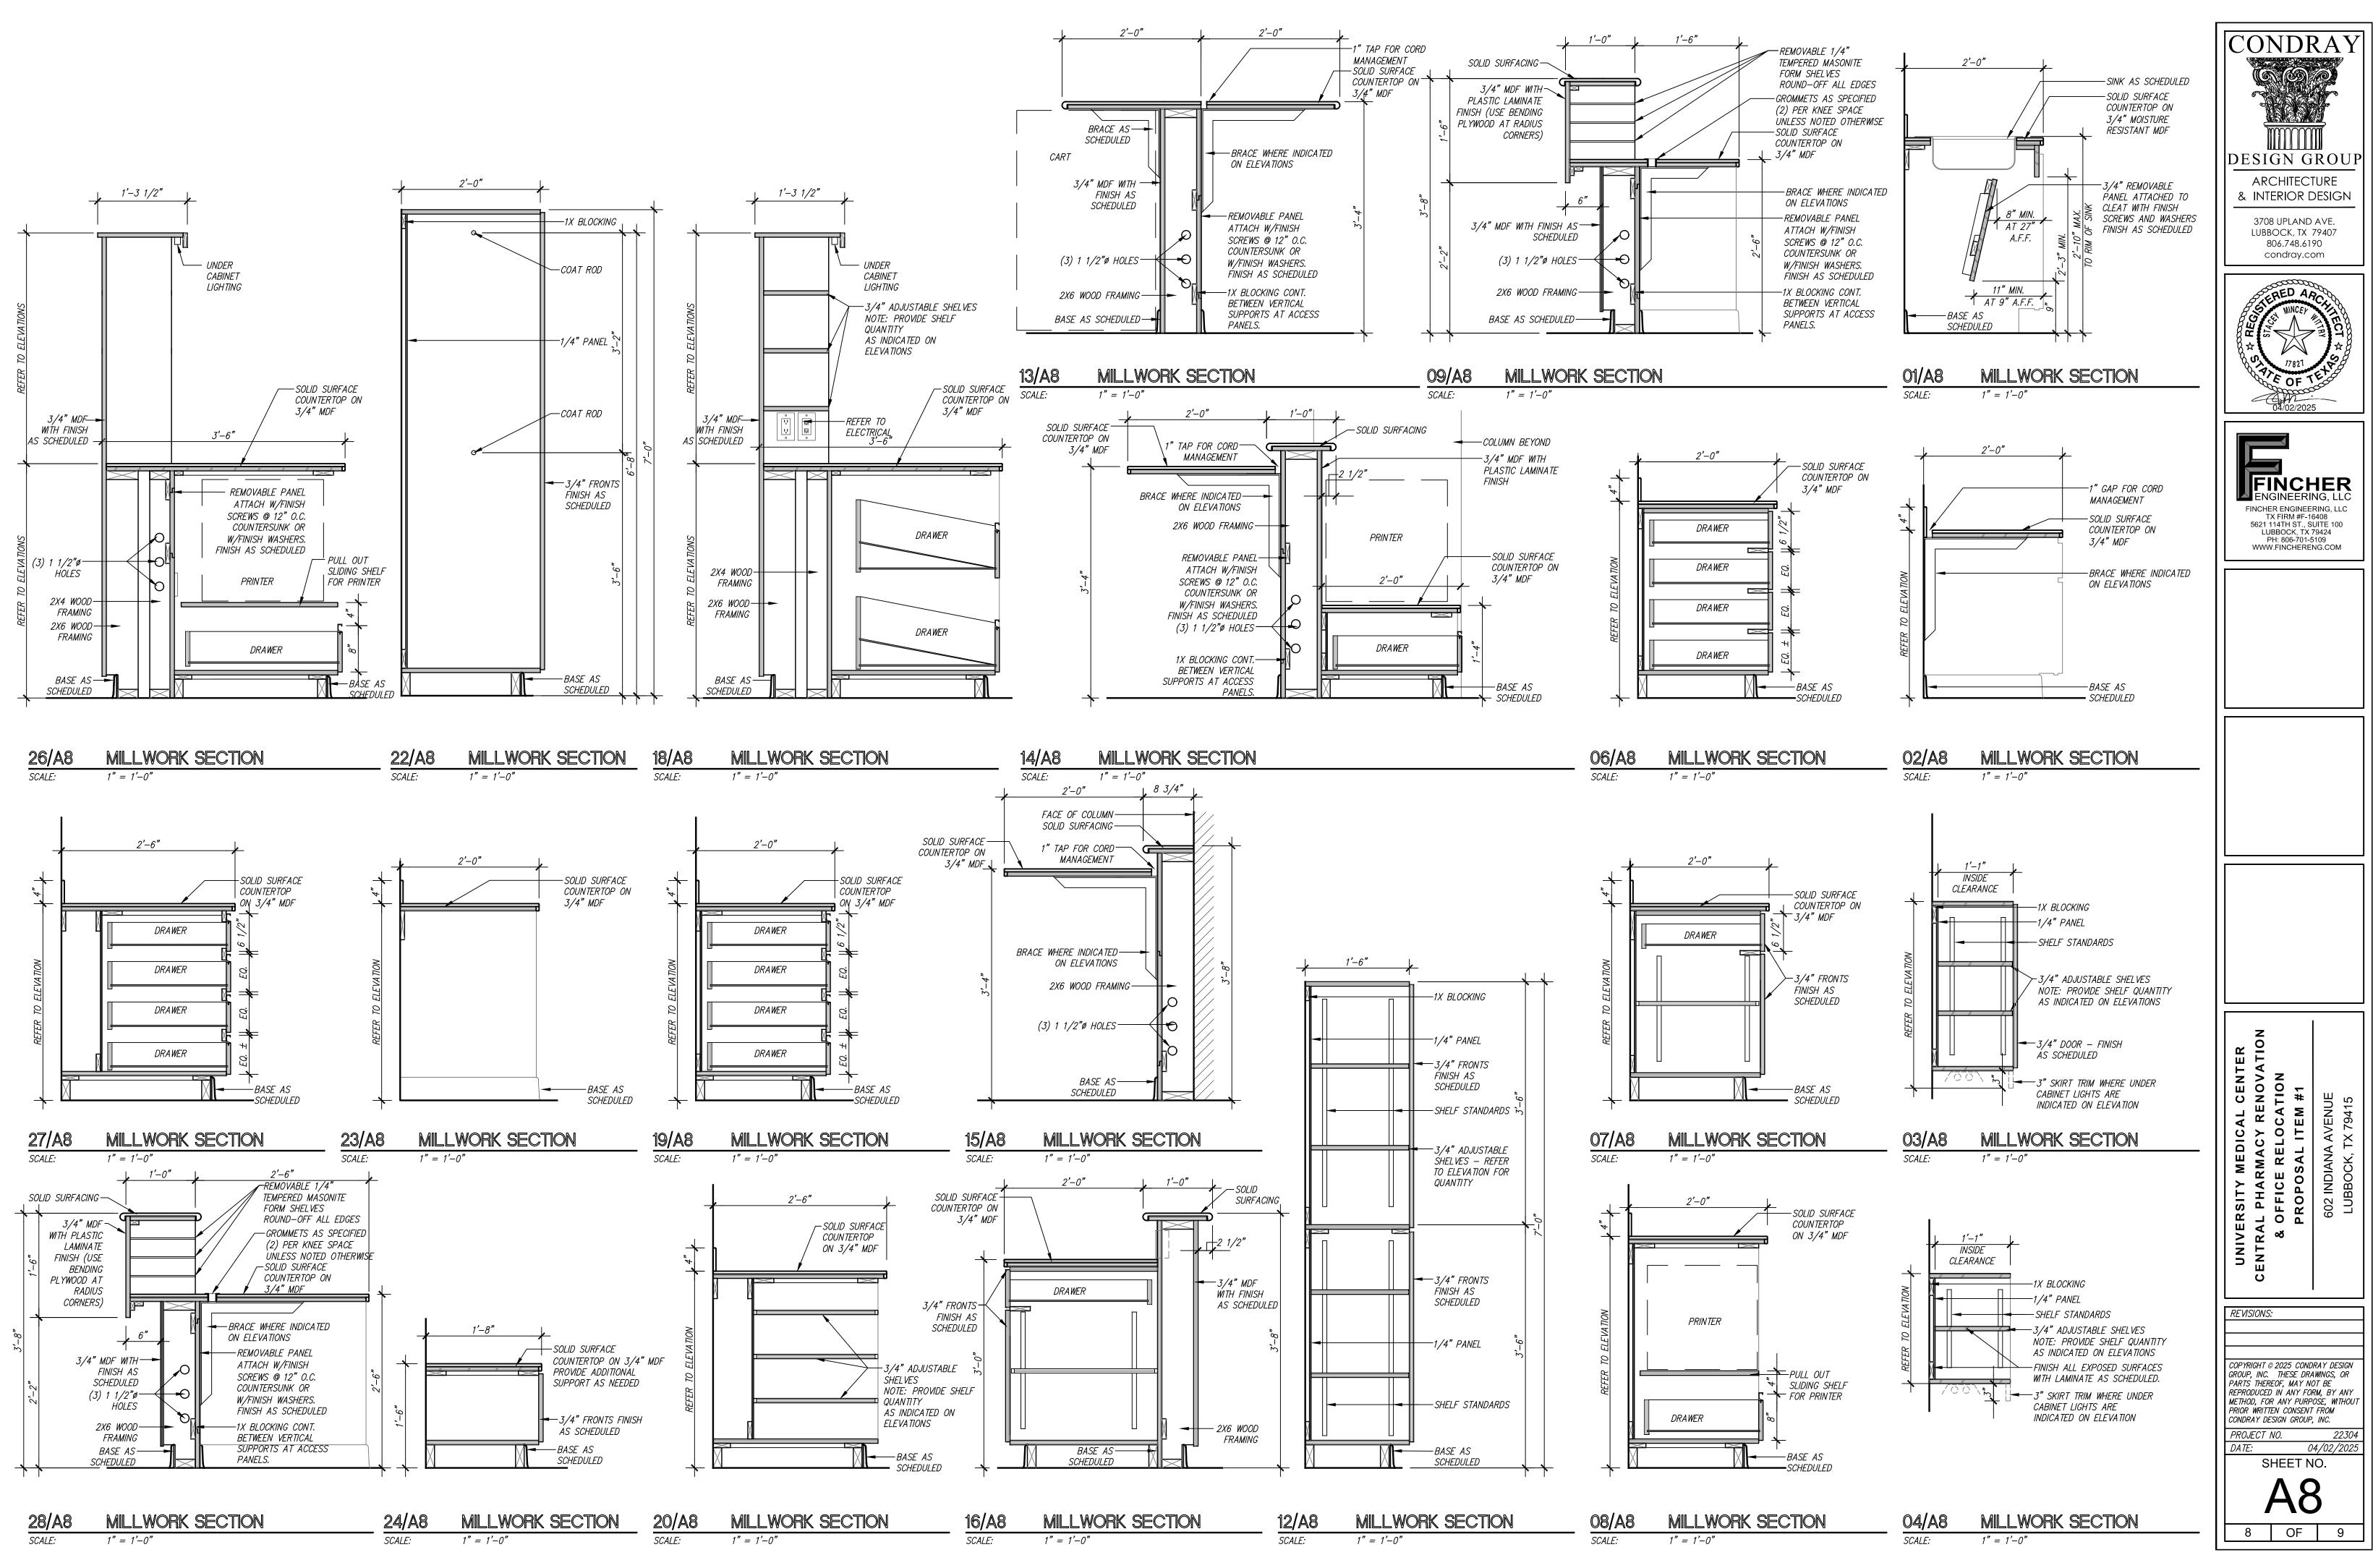
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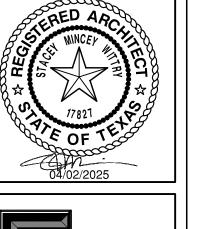
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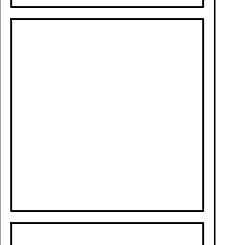
04/02/2025 SHEET NO.

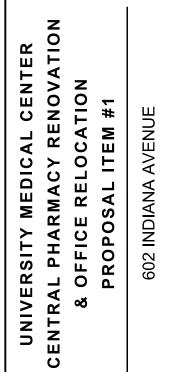


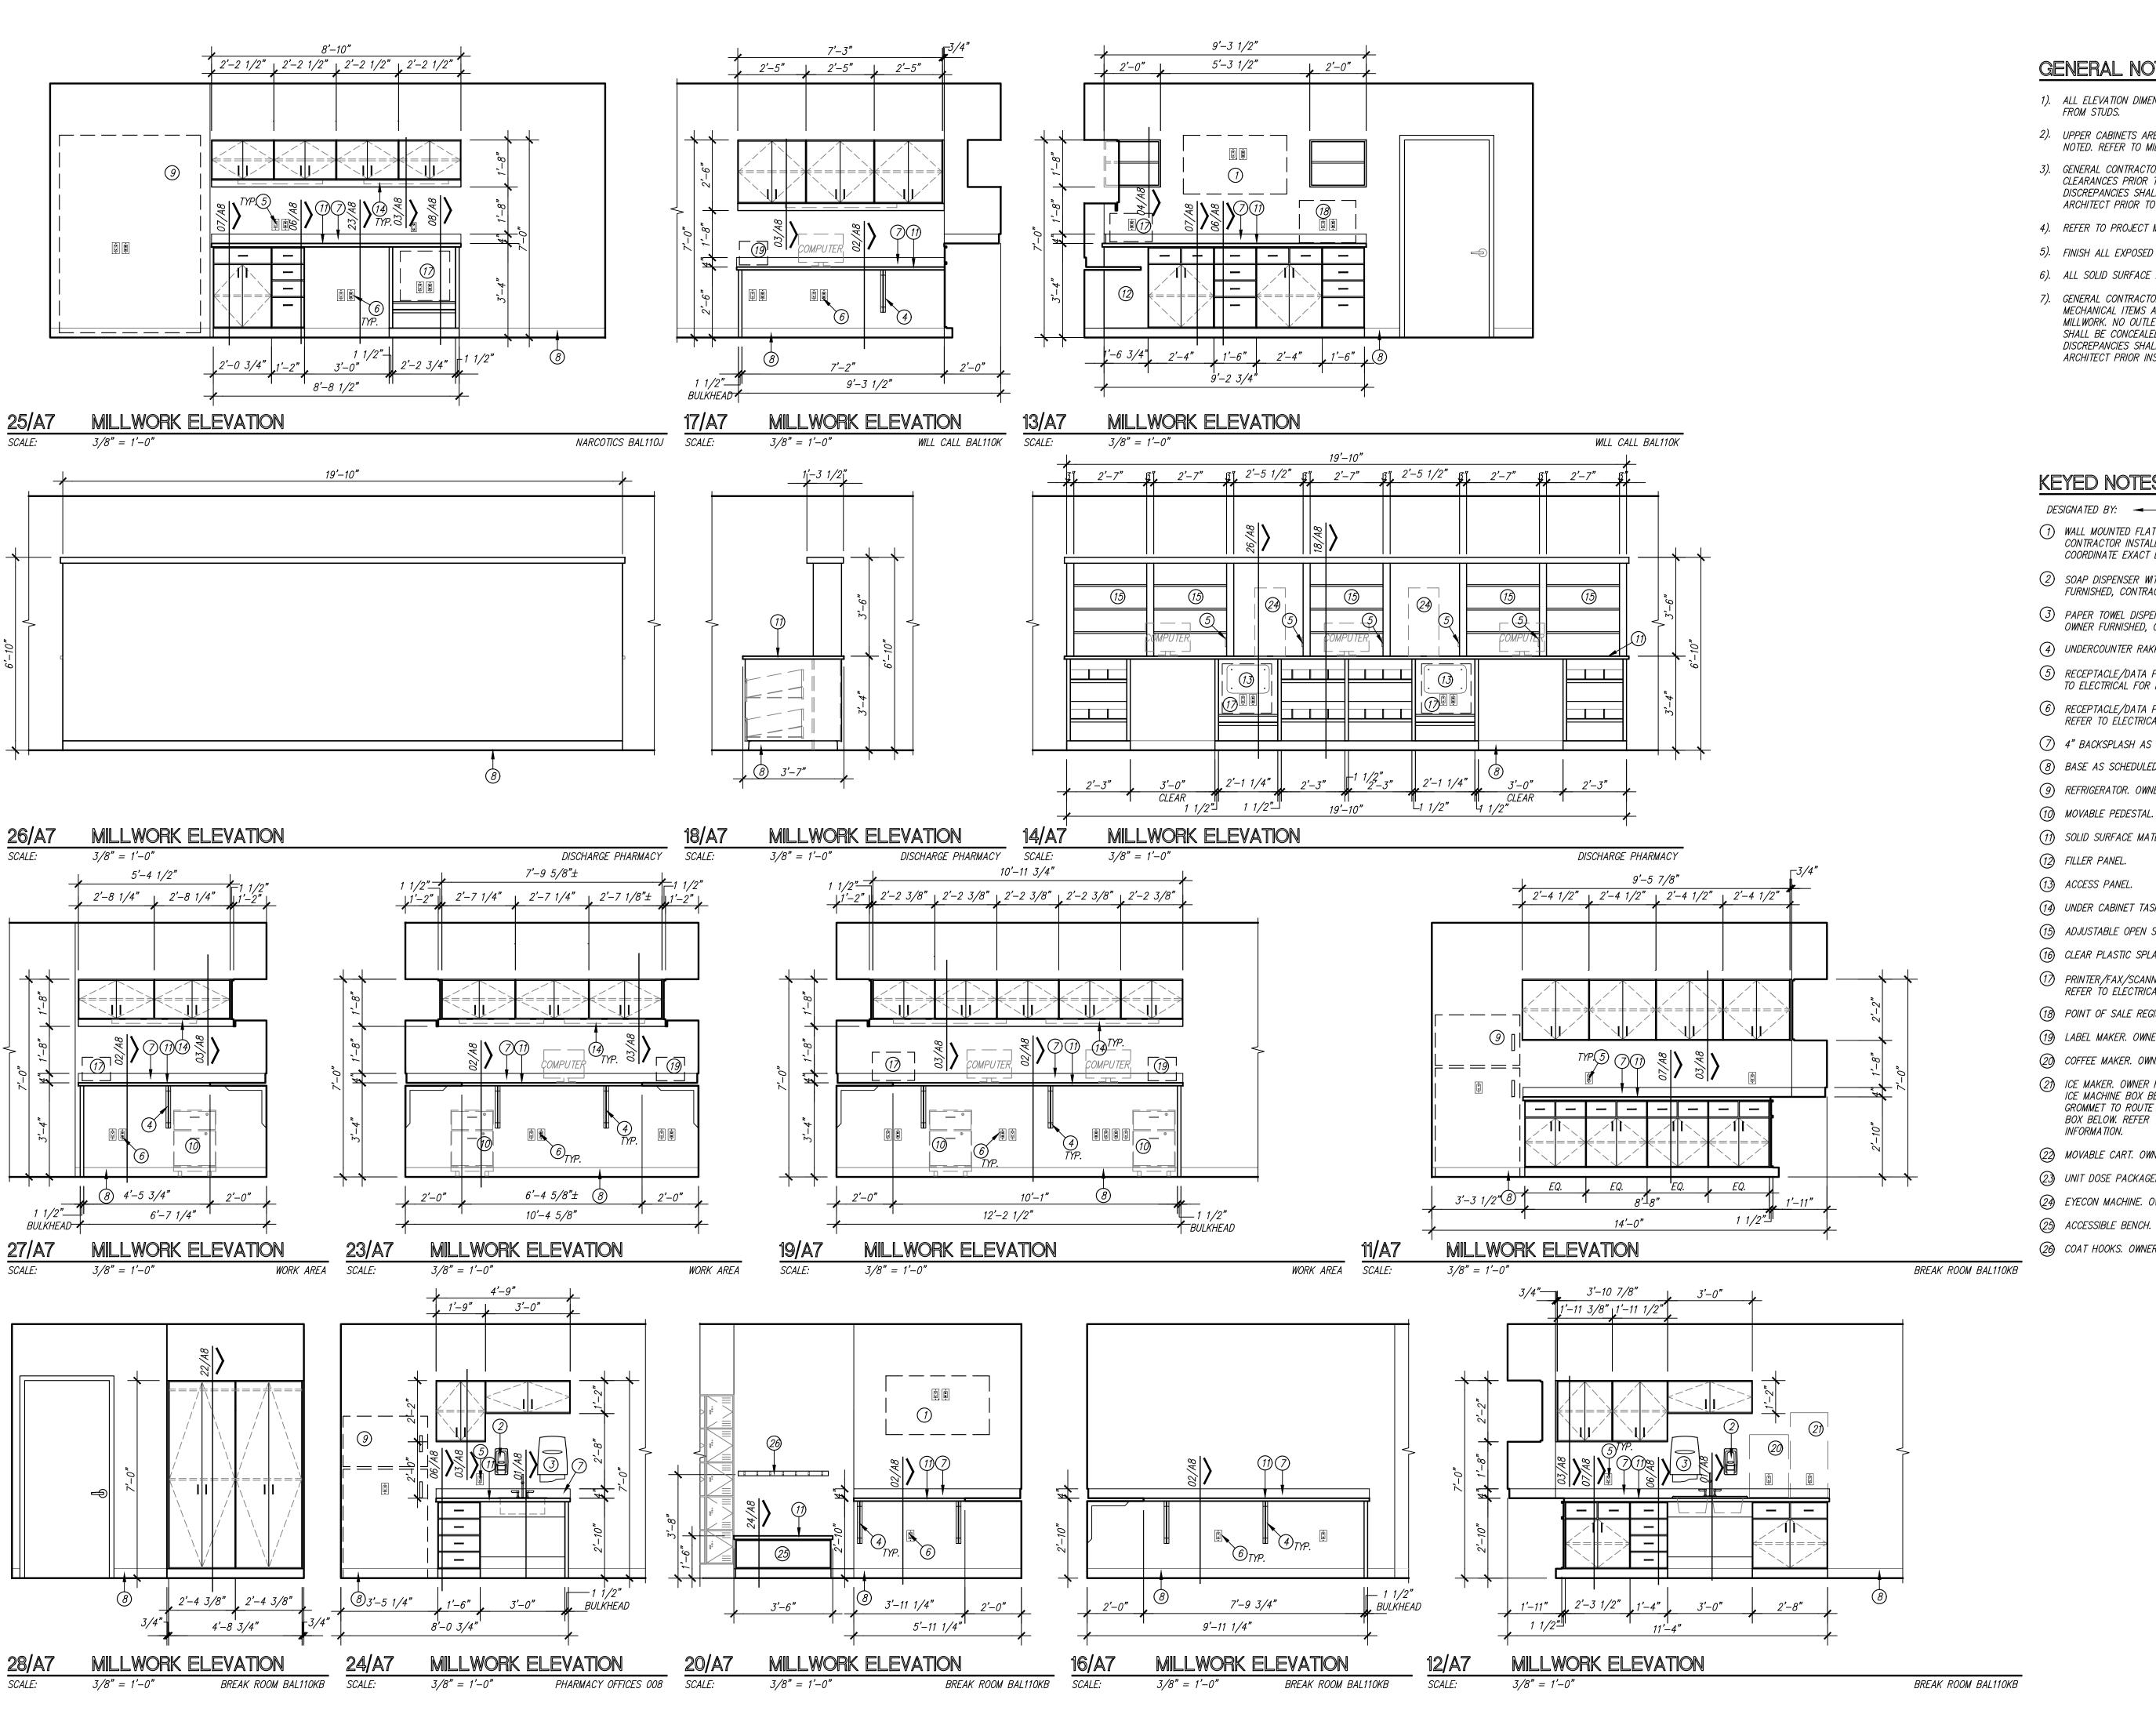








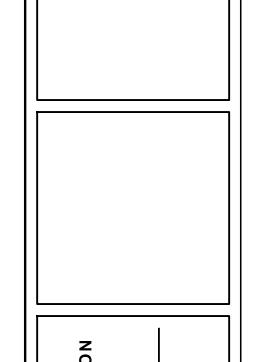

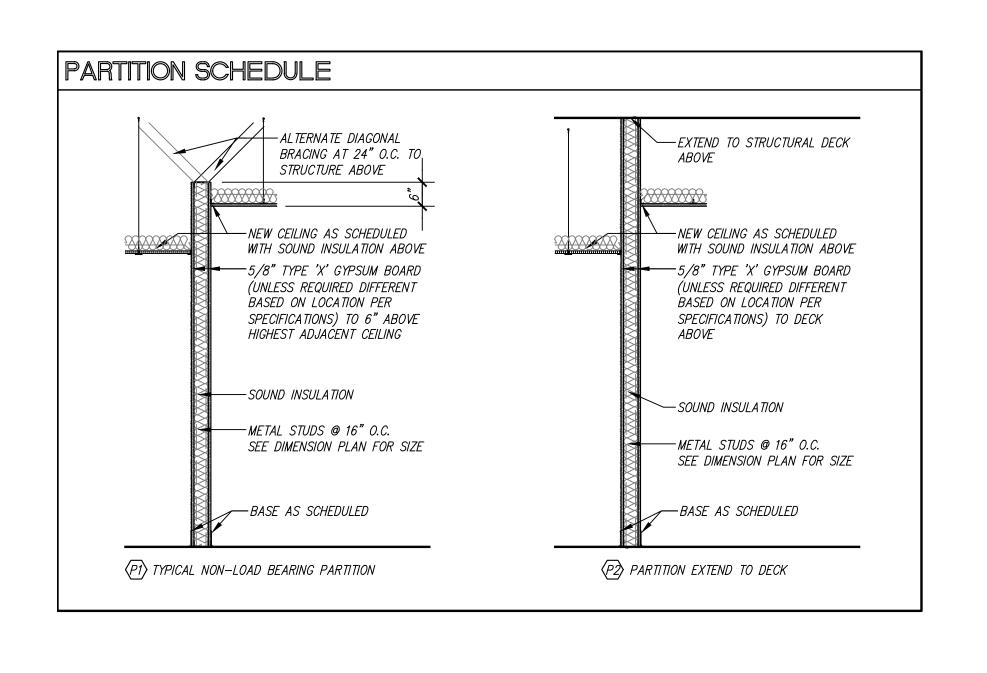

CRIPPLE STUD - 1/4"-MIN. CLEARANCE

\*HEADER DESIGN -

REFER TO SCHEDULE

LOCATE JAMB ANCHORS—

STRIKE SIDE TO OCCUR

FLOOR ANCHORS SECURED-

WITH MINIMUM OF TWO SUITABLE FASTENERS

AS REQUIRED — ON

DIRECTLY OPPOSITE

HINGE SIDE


FOR HEADER TYPE


STEEL STUDS —

-- RUNNER

FASTENED W/

SCREWS TO STEEL STUDS

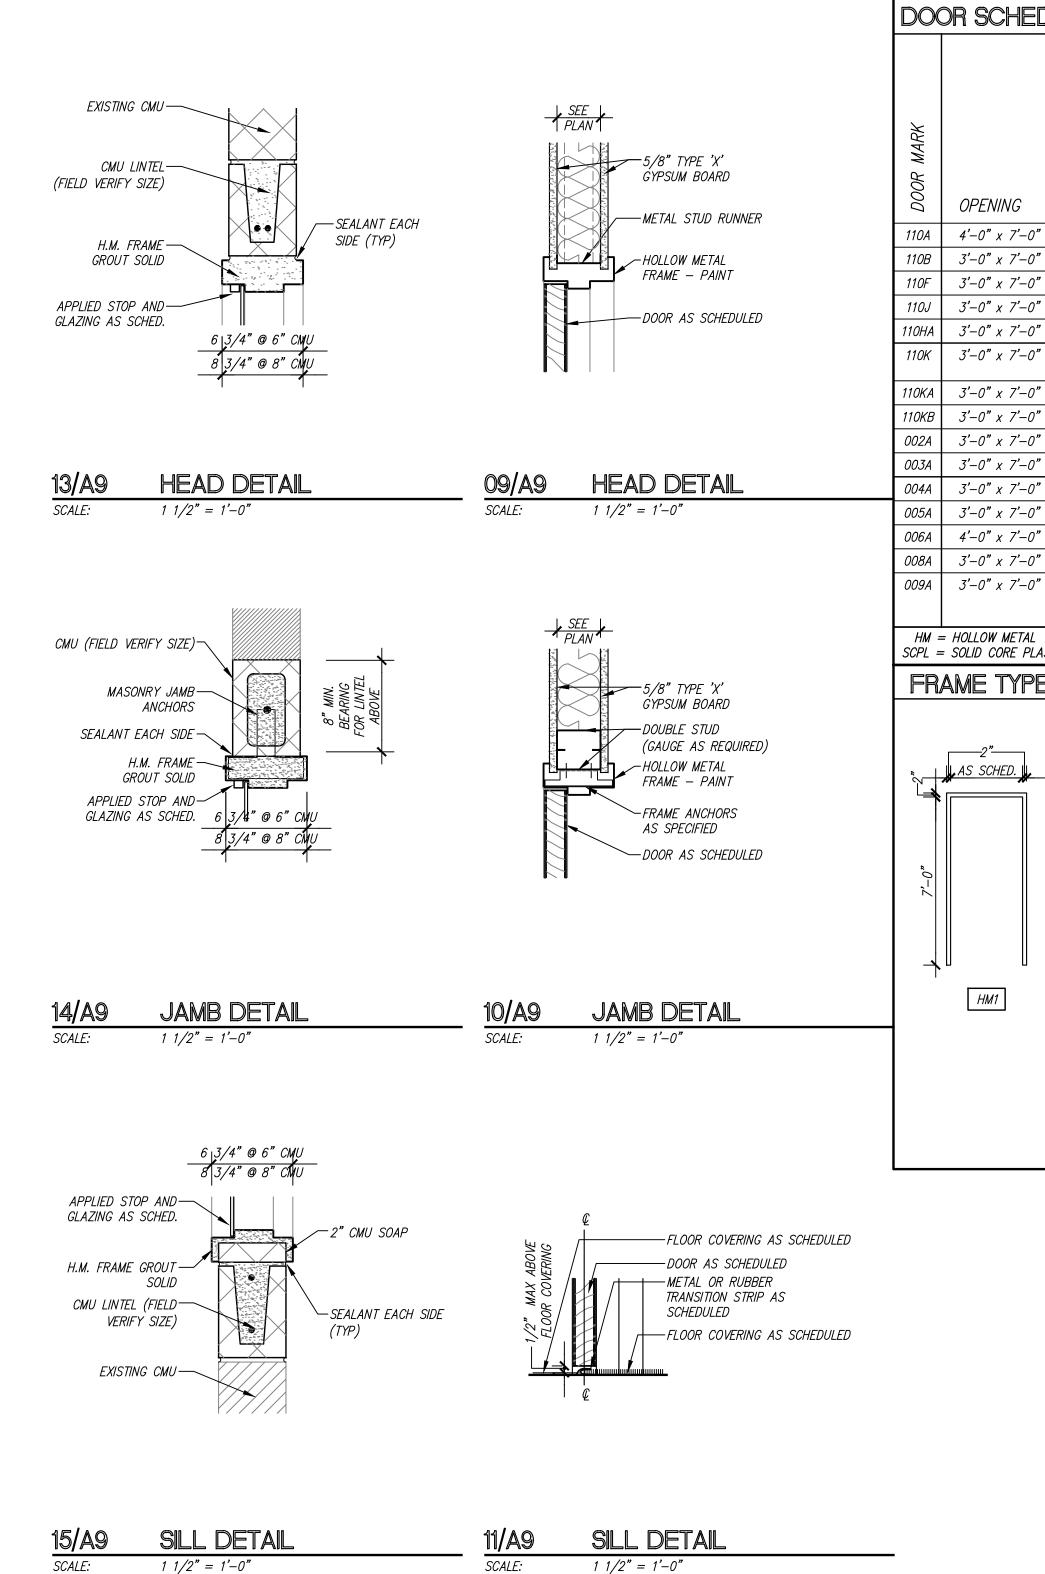

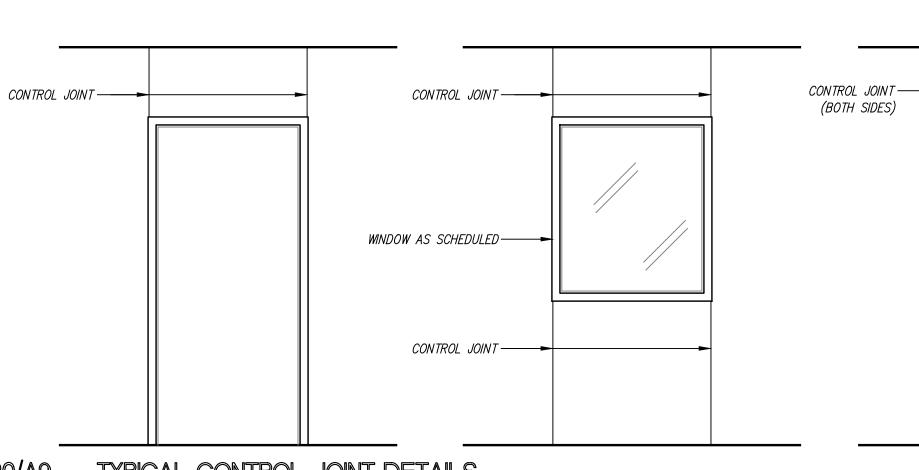

∟*FURRDOWN OR* FRAMED OPENING

TYPICAL DOOR FRAMING

\*INTERIOR FRAMING HEADER SCHEDULE\*

- AT OPENINGS 3'-6" WIDE OR

LESS STUD RUNNER IS

SUFFICIENT FOR HEADER

- AT OPENINGS > 3'-6" AND < 8'-0" USE A 6" BOX BEAM

- AT OPENINGS > 8'-0" AND

< 10'-0" USE AN 8" BOX

CONSULT WITH ARCHITECT

- AT OPENINGS > 10'-0"

HEADER

BEAM HEADER

SCALE: NOT TO SCALE

TYPICAL CONTROL JOINT DETAILS

DOC	OR SCHEDULE	<u> </u>												
								DETAILS						
DOOR MARK	OPENING	DOOR TYPE	PAIR	DOOR MATERIAL	FIRE RATING	FRAME TYPE	HEAD	JAMB	SILL	REMARKS				
110A	4'-0" x 7'-0"	Α	_	SCPL	_	НМ1	09/A9	10/A9	11/A9	-				
110B	3'-0" x 7'-0"	В	_	SCPL	_	НМ1	09/A9	10/A9	11/A9	USE 3005A DOOR FROM 22008 3RD FLOOR EAST TOWER				
110F	3'-0" x 7'-0"	В	_	SCPL	90 MIN.	НМ1	_	_	_	_				
110J	3'-0" x 7'-0"	Α	_	SCPL	90 MIN.	EX	_	_	_	REUSE ALL EXISTING HARDWARE INCLUDIING TAP BADGE				
110HA	3'-0" x 7'-0"	Α	_	SCPL	_	НМ1	09/A9	10/A9	11/A9	USE 3088A DOOR FROM 22008 3RD FLOOR EAST TOWER				
110K	3'-0" x 7'-0"	Α	_	SCPL	_	HM1	09/A9	10/A9	11/A9	USE 3118A DOOR FROM 22008 3RD FLOOR EAST TOWER INSTALL PEEP HOLE				
110KA	3'-0" x 7'-0"	Α		SCPL		НМ1	09/A9	10/A9	11/A9	USE 3141A DOOR FROM 22008 3RD FLOOR EAST TOWER				
110KB	3'-0" x 7'-0"	В	_	SCPL	1	НМ1	09/A9	10/A9	11/A9	INSTALL PEEPHOLE REUSE EXISTING KEYPAD ACCESS				
002A	3'-0" x 7'-0"	Α	_	SCPL	1	НМ1	09/A9	10/A9	11/A9	USE 3121A DOOR FROM 22008 3RD FLOOR EAST TOWER				
003A	3'-0" x 7'-0"	Α	_	SCPL	ı	НМ1	09/A9	10/A9	11/A9	USE 3112A DOOR FROM 22008 3RD FLOOR EAST TOWER				
004A	3'-0" x 7'-0"	Α	_	SCPL	_	НМ1	09/A9	10/A9	11/A9	USE 3127A DOOR FROM 22008 3RD FLOOR EAST TOWER				
005A	3'-0" x 7'-0"	Α	_	SCPL	_	НМ1	09/A9	10/A9	11/A9	USE 3107A DOOR FROM 22008 3RD FLOOR EAST TOWER				
006A	4'-0" x 7'-0"	Α	_	SCPL	1	НМ1	09/A9	10/A9	11/A9					
008A	3'-0" x 7'-0"	Α	_	SCPL	_	НМ1	09/A9	10/A9	11/A9	USE 3101A DOOR FROM 22008 3RD FLOOR EAST TOWER				
009A	3'-0" x 7'-0"	Α	_	SCPL	_	НМ1	09/A9	10/A9	11/A9	USE 3111A DOOR FROM 22008 3RD FLOOR EAST TOWER				

SCPL = SOLID CORE PLASTIC LAMINATE DOOR TYPES FRAME TYPES HM = HOLLOW METALAS SCHED. G2 @ 110F HM1 HM2 TWO-HOUR RATED GLAZING SOLID CORE DOOR MATERIAL WOOD DOOR WI/METAL FRAME P. LAM FINISH VISION PANEL FINISH

EX = EXISTING

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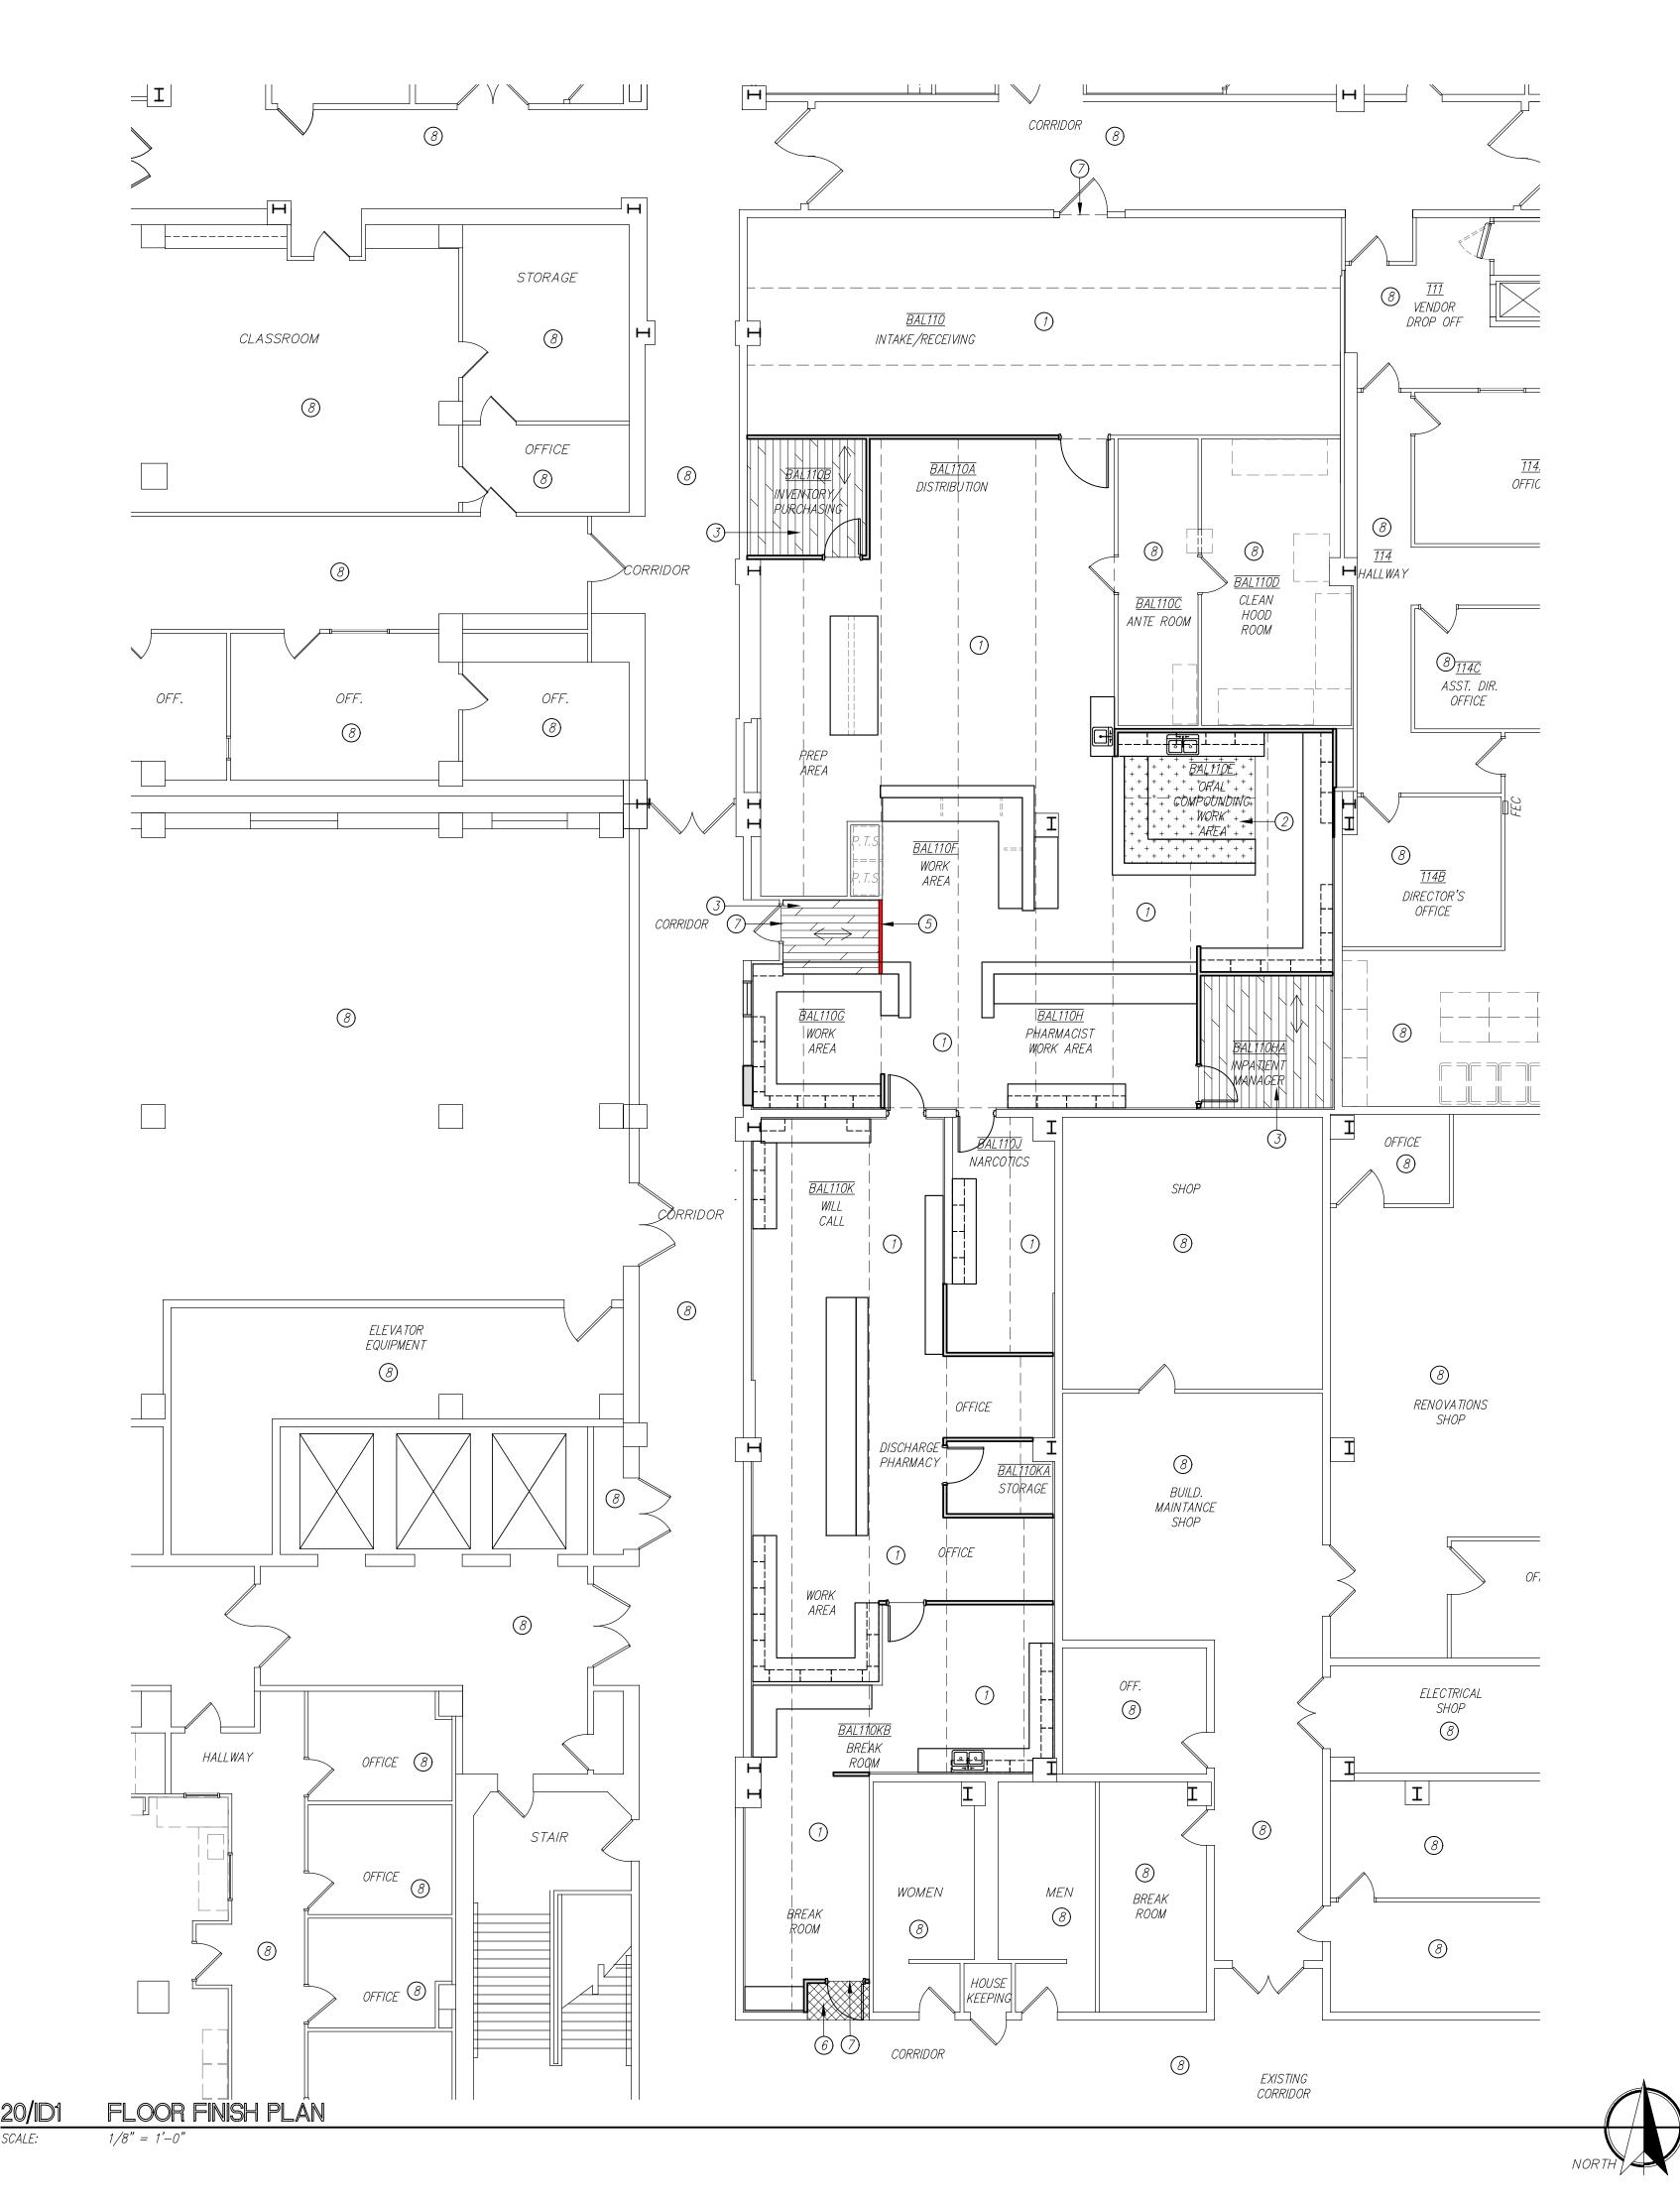
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CENTRAL PHARMACY RENOVATION
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PROPOSAL ITEM #1

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SHEET NO. OF



8

PHARMACY. OFFICES

TELEMETRY STORAGE (8)

COMM

8

FLOOR FINISH PLAN

8

ELECTRICAL 8

DIRECTOR

**OFFICE** 

<u>004</u>

ADMIN.

<u>003</u> OFFICE

 $\overline{002} \Longleftrightarrow$ 

ROOM 3

CONFERENCE

<u>010</u> 7 CORRIDOR

MECHANICAL

# GENERAL NOTES


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- 2). ALL WORK IS TO BE PERFORMED ACCORDING TO MANUFACTURER'S RECOMMENDED METHODS.
- 3). FIELD VERIFY ALL DIMENSIONS NEW OR EXISTING PRIOR TO CONSTRUCTION AND ADJUST WHERE REQUIRED TO PROVIDE A PROPER AND COMPLETE INSTALLATION. NOTIFY THE ARCHITECT OF ANY DISCREPANCIES WITH EXISTING OR NEW CONDITIONS.
- PROVIDE SMOOTH TRANSITION WHERE NEW CONSTRUCTION INTERSECTS WITH EXISTING CONDITIONS. IN ALL AREAS ADJACENT TO NEW CONSTRUCTION, REPAIR/REFINISH AND INSTALL NEW WALL BASE, PAINT, ETC. WHERE NECESSARY TO AVOID PATCHES OR INCONSISTENT FINISHES.
- 5). A PRE-INSTALLATION MEETING WITH THE ARCHITECT IS REQUIRED PRIOR TO THE INSTALLATION OF VINYL FLOORING AND WALL PROTECTIVE PRODUCTS.
- 6). INSTALL FLOORING TO WALL UNDER OPEN MILLWORK OR EQUIPMENT.
- 7). INCLUDE TRANSITION STRIPS BETWEEN DIFFERENT FLOORING TYPES AS SCHEDULED.



DESIGN GROUP ARCHITECTURE

> 3708 UPLAND AVE. LUBBOCK, TX 79407 806.748.6190 condray.com

& INTERIOR DESIGN

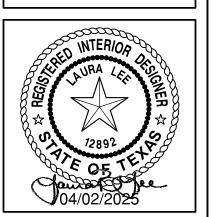



# KEYED NOTES

DESIGNATED BY: -

- (1) INSTALL SHEET VINYL SV1 (LIGHT NEUTRAL) IN THIS LOCATION.
- (2) INSTALL SHEET VINYL SV2 (DARK NEUTRAL) IN THIS LOCATION.
- (3) INSTALL SHEET VINYL SV3 (WOOD LOOK) IN THIS LOCATION.
- 4) INSTALL SHEET VINYL SV4 (LINEN LOOK) IN THIS LOCATION.
- (5) INSTALL SHEET VINYL SV5 (RED) AS REDLINE IN THIS LOCATION.
- (6) INSTALL VINYL TILE VCT1 IN THIS LOCATION.
- 7) INSTALL TRANSITION STRIP TS1 IN THIS LOCATION.

# 8) NO WORK IN THIS LOCATION.

# FLOOR FINISH LEGEND




SV3 SHEET VINYL



SV4 SHEET VINYL



VCT1 VINYL COMPOSITION TILE

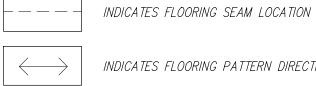


INDICATES FLOORING PATTERN DIRECTION

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& OFFICE RELOCATION
PROPOSAL ITEM #1



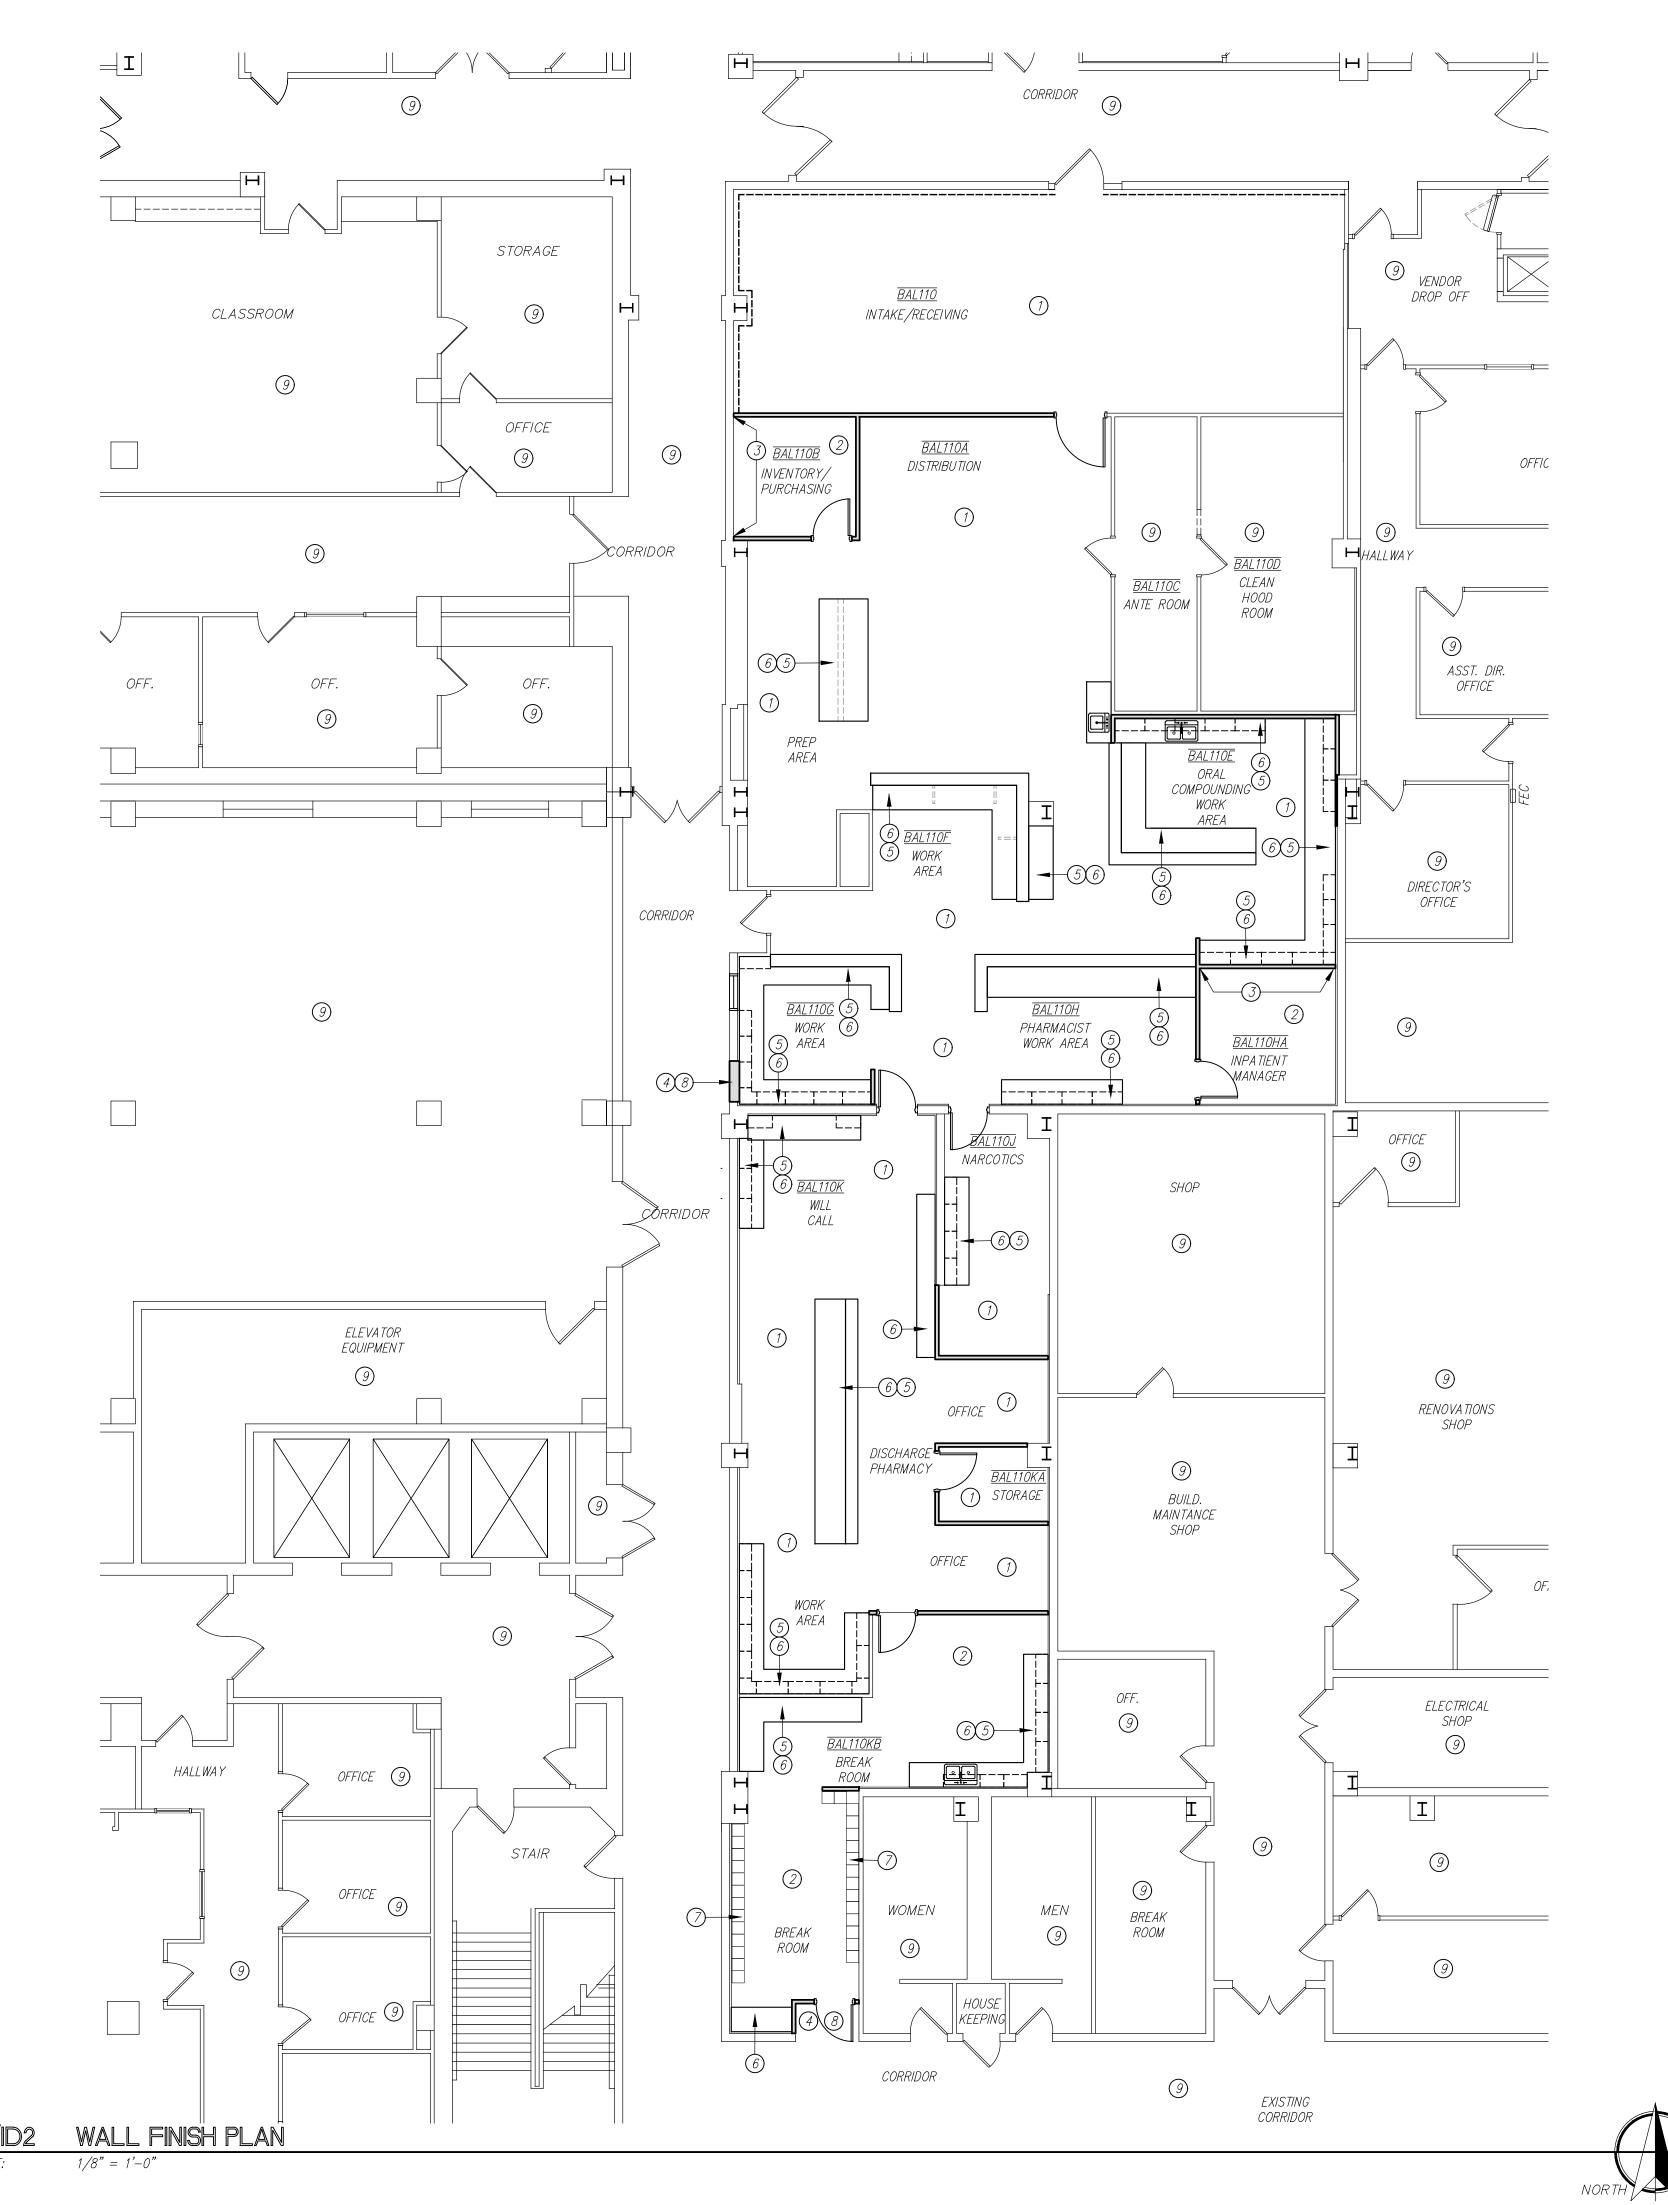

DIAL YSIS

PHARMACY OFFICES

TELEMETRY STORAGE 9

COMM

9

WALL FINISH PLAN

<u>001</u> : (3) ENTRY

CORRIDOR

OFFICE 2

ELECTRICAL 9

DIRECTOR

OFFICE

003 OFFICE

CONFERENCE ROOM 9

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- 6). FIELD PAINT P1 TO GO ON ALL WALLS, NEW AND EXISTING, WITHIN PHARMACY PROJECT SCOPE, WHERE PAINT COLOR IS NOT INDICATED ON THIS PLAN.
- 7). FIELD PAINT P2 TO GO ON ALL WALLS, NEW AND EXISTING, WITHIN PHARMACY OFFICES PROJECT SCOPE, WHERE PAINT COLOR IS NOT INDICATED ON THIS PLAN.
- 8). INCLUDE ALL TRIM, CONNECTOR, AND END CAP PIECES FOR COMPLETE INSTALLATION OF FINISHES, UNLESS NOTED OTHERWISE.
- 9). CAULK AT ALL TRANSITIONS BETWEEN DISSIMILAR TYPES OF MATERIALS AND SURFACES WITH COLOR—MATCHED CAULK.




DESIGN GROUP

ARCHITECTURE

& INTERIOR DESIGN

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# KEYED NOTES

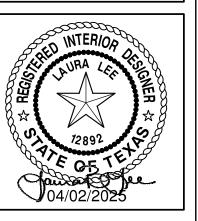DESIGNATED BY: - #)

- (1) PAINT WALL P1 IN THIS LOCATION (WHITE COLOR).
- 2 PAINT WALL P2 IN THIS LOCATION (LIGHT NEUTRAL FIELD COLOR).
- ③ PAINT WALL P3 IN THIS LOCATION (DARK NEUTRAL ACCENT COLOR).
- 4) PAINT WALL P4 IN THIS LOCATION (LIGHT NEUTRAL CORRIDOR
- (5) SSM1 TO BE INSTALLED AT THIS LOCATION AS SCHEDULED.
- 6 PL1 TO BE INSTALLED AT THIS LOCATION AS SCHEDULED.
- (6) PL1 10 BE INSTALLED AT THIS LOCATION AS SCHEDULED.

  (7) ML1 TO BE INSTALLED AT THIS LOCATION AS SCHEDULED.
- (8) PROVIDE SMOOTH TRANSITION IN THIS LOCATION WHERE NEW WALLS INTERSECT WITH EXISTING WALL CONDITIONS.
- NO WORK TO BE PERFORMED IN THIS AREA.

WALL FINISH LEGEND

\_\_\_\_\_ WP1 AND TC1 WALL PROTECTION (WAINSCOT)

FRP1 WALL PROTECTION


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PROPOSAL ITEM #1

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> ATE: 04/02/202 SHEET NO.

1D2 2 OF 2



- A. VERIFY EXACT LOCATION OF ALL EXISTING EQUIPMENT, DUCTWORK, PIPING, DIFFUSERS, AND GRILLES AT JOBSITE.
- B. CONTRACTOR SHALL WALK THE SITE AND BECOME FAMILIAR WITH ALL EXISTING SYSTEMS AND INSTALLATIONS. CONTRACTOR SHALL TAKE CARE TO PROTECT ALL OPERATIONAL SYSTEMS. ANY EXISTING SYSTEMS THAT ARE DAMAGED DURING CONSTRUCTION SHALL BE REPAIRED OR REPLACED AT THE EXPENSE OF THE CONTRACTOR.
- C. FOR ALL ITEMS SHOWN TO BE REMOVED, REMOVE ALL ASSOCIATED ITEMS INCLUDING HANGERS, SUPPORTS, PIPE RUNOUTS, ELECTRICAL WIRING, ECT.
- D. CONTRACTOR SHALL COORDINATE ALL MECHANICAL DISCONNECTIONS AND INTERRUPTIONS WITH BUILDING OWNER. VERIFY EXACT SCHEDULE AND PHASING OF PROJECT WITH ARCHITECT.
- E. THE BUILDING OWNER SHALL RETAIN THE FULL RIGHTS OF SALVAGE FOR ALL MECHANICAL EQUIPMENT INDICATED TO BE REMOVED (VAV BOXES, FAN COIL UNITS, EXT). THE CONTRACTOR SHALL COORDINATE WITH OWNER ON ALL SALVAGED ITEMS. THE CONTRACTOR SHALL DELIVER THESE PIECES OF EQUIPMENT TO A LOCATION AS DIRECTED BY THE OWNER. FOR ALL ITEMS THAT THE OWNER DOES NOT SALVAGE, THE CONTRACTOR SHALL DISPOSE OF AS REQUIRED.
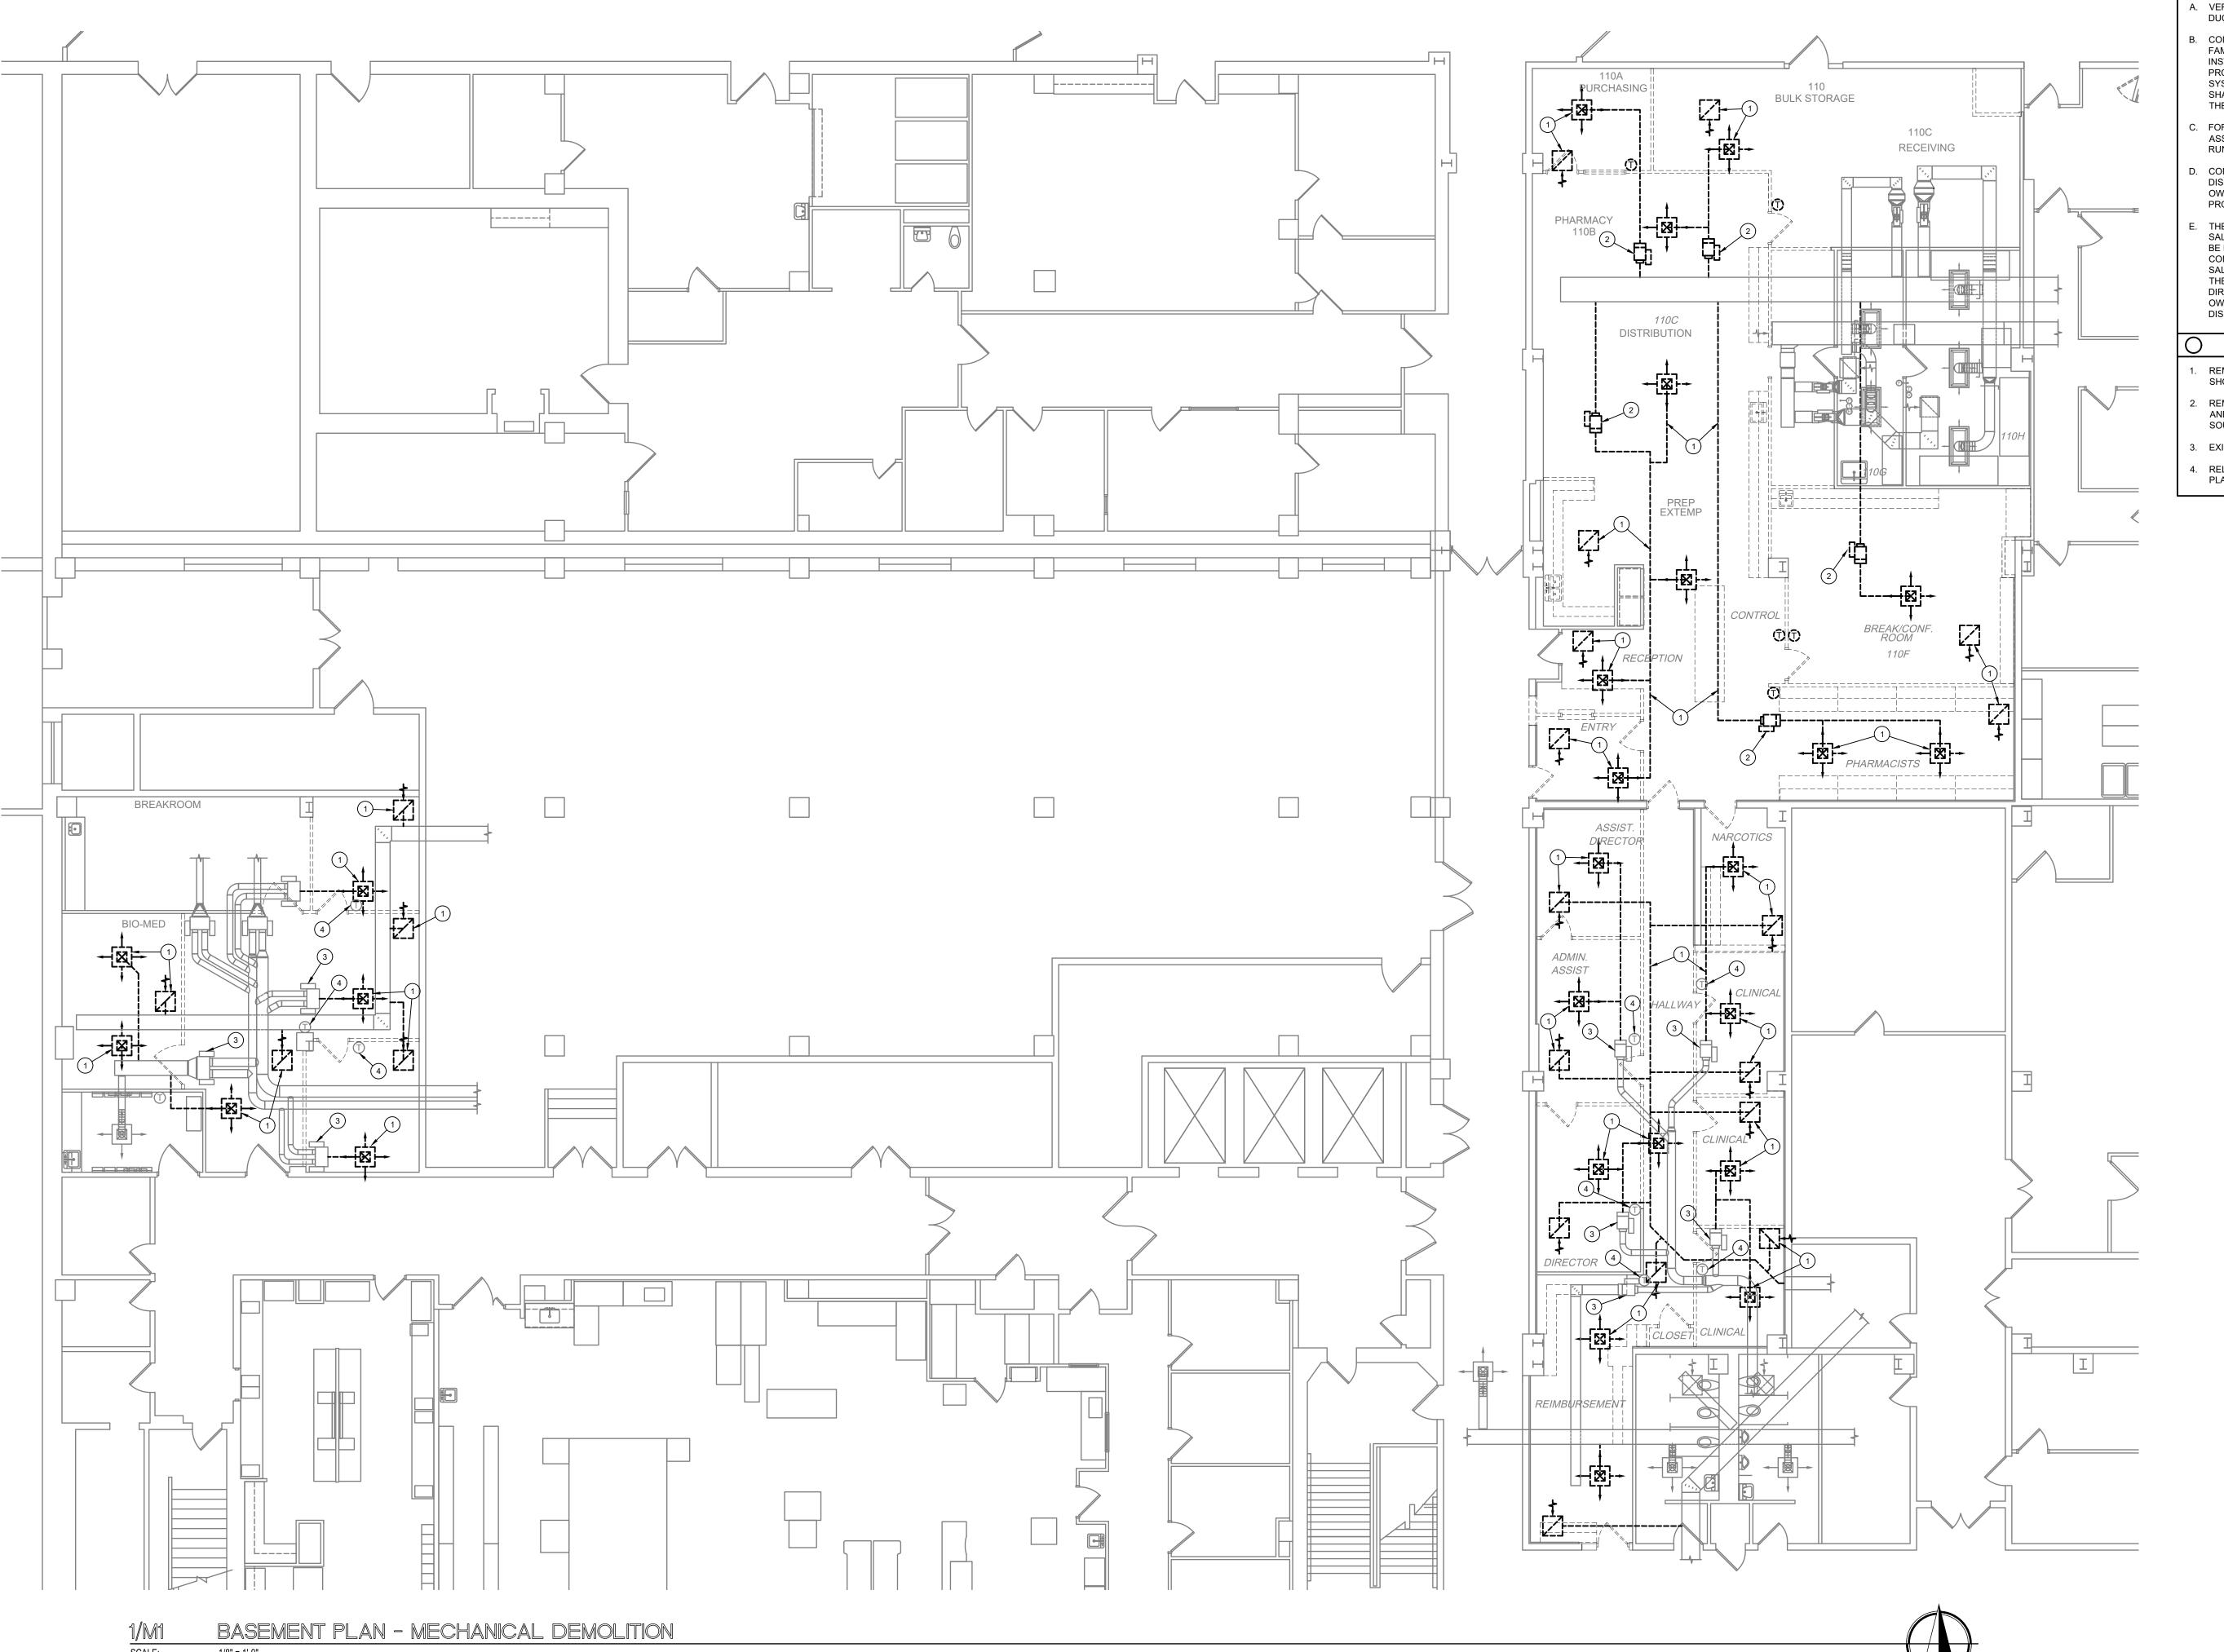
#### KEYED NOTES

- REMOVE EXISTING DUCTWORK, DIFFUSERS, AND GRILLES SHOWN DASHED.
- 2. REMOVE EXISTING PNEUMATIC VAV BOX SHOWN DASHED, AND ASSOCIATED THERMOSTAT AND TUBING BACK TO SOURCE.
- 3. EXISTING VAV BOX TO REMAIN.
- 4. RELOCATE EXISTING THERMOSTAT AS SHOWN ON NEW PLAN.




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RAL PHARMACY RENOVATION
& OFFICE RELOCATION
PROPOSAL ITEM #1
602 INDIANA AVENUE


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 PROJECT NO.
 22304

 DATE:
 04/02/2025

 SHEET NO.

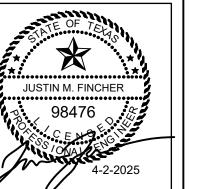

- A. VERIFY EXACT LOCATION OF ALL EXISTING EQUIPMENT,
- B. CONTRACTOR SHALL WALK THE SITE AND BECOME FAMILIAR WITH ALL EXISTING SYSTEMS AND INSTALLATIONS. CONTRACTOR SHALL TAKE CARE TO PROTECT ALL OPERATIONAL SYSTEMS. ANY EXISTING SYSTEMS THAT ARE DAMAGED DURING CONSTRUCTION SHALL BE REPAIRED OR REPLACED AT THE EXPENSE OF THE CONTRACTOR.
- C. FOR ALL ITEMS SHOWN TO BE REMOVED, REMOVE ALL ASSOCIATED ITEMS INCLUDING HANGERS, SUPPORTS, PIPE RUNOUTS, ELECTRICAL WIRING, ECT.
- CONTRACTOR SHALL COORDINATE ALL MECHANICAL DISCONNECTIONS AND INTERRUPTIONS WITH BUILDING OWNER. VERIFY EXACT SCHEDULE AND PHASING OF PROJECT WITH ARCHITECT.
- THE BUILDING OWNER SHALL RETAIN THE FULL RIGHTS OF SALVAGE FOR ALL MECHANICAL EQUIPMENT INDICATED TO BE REMOVED (VAV BOXES, FAN COIL UNITS, EXT). THE CONTRACTOR SHALL COORDINATE WITH OWNER ON ALL SALVAGED ITEMS. THE CONTRACTOR SHALL DELIVER THESE PIECES OF EQUIPMENT TO A LOCATION AS DIRECTED BY THE OWNER. FOR ALL ITEMS THAT THE OWNER DOES NOT SALVAGE, THE CONTRACTOR SHALL DISPOSE OF AS REQUIRED.
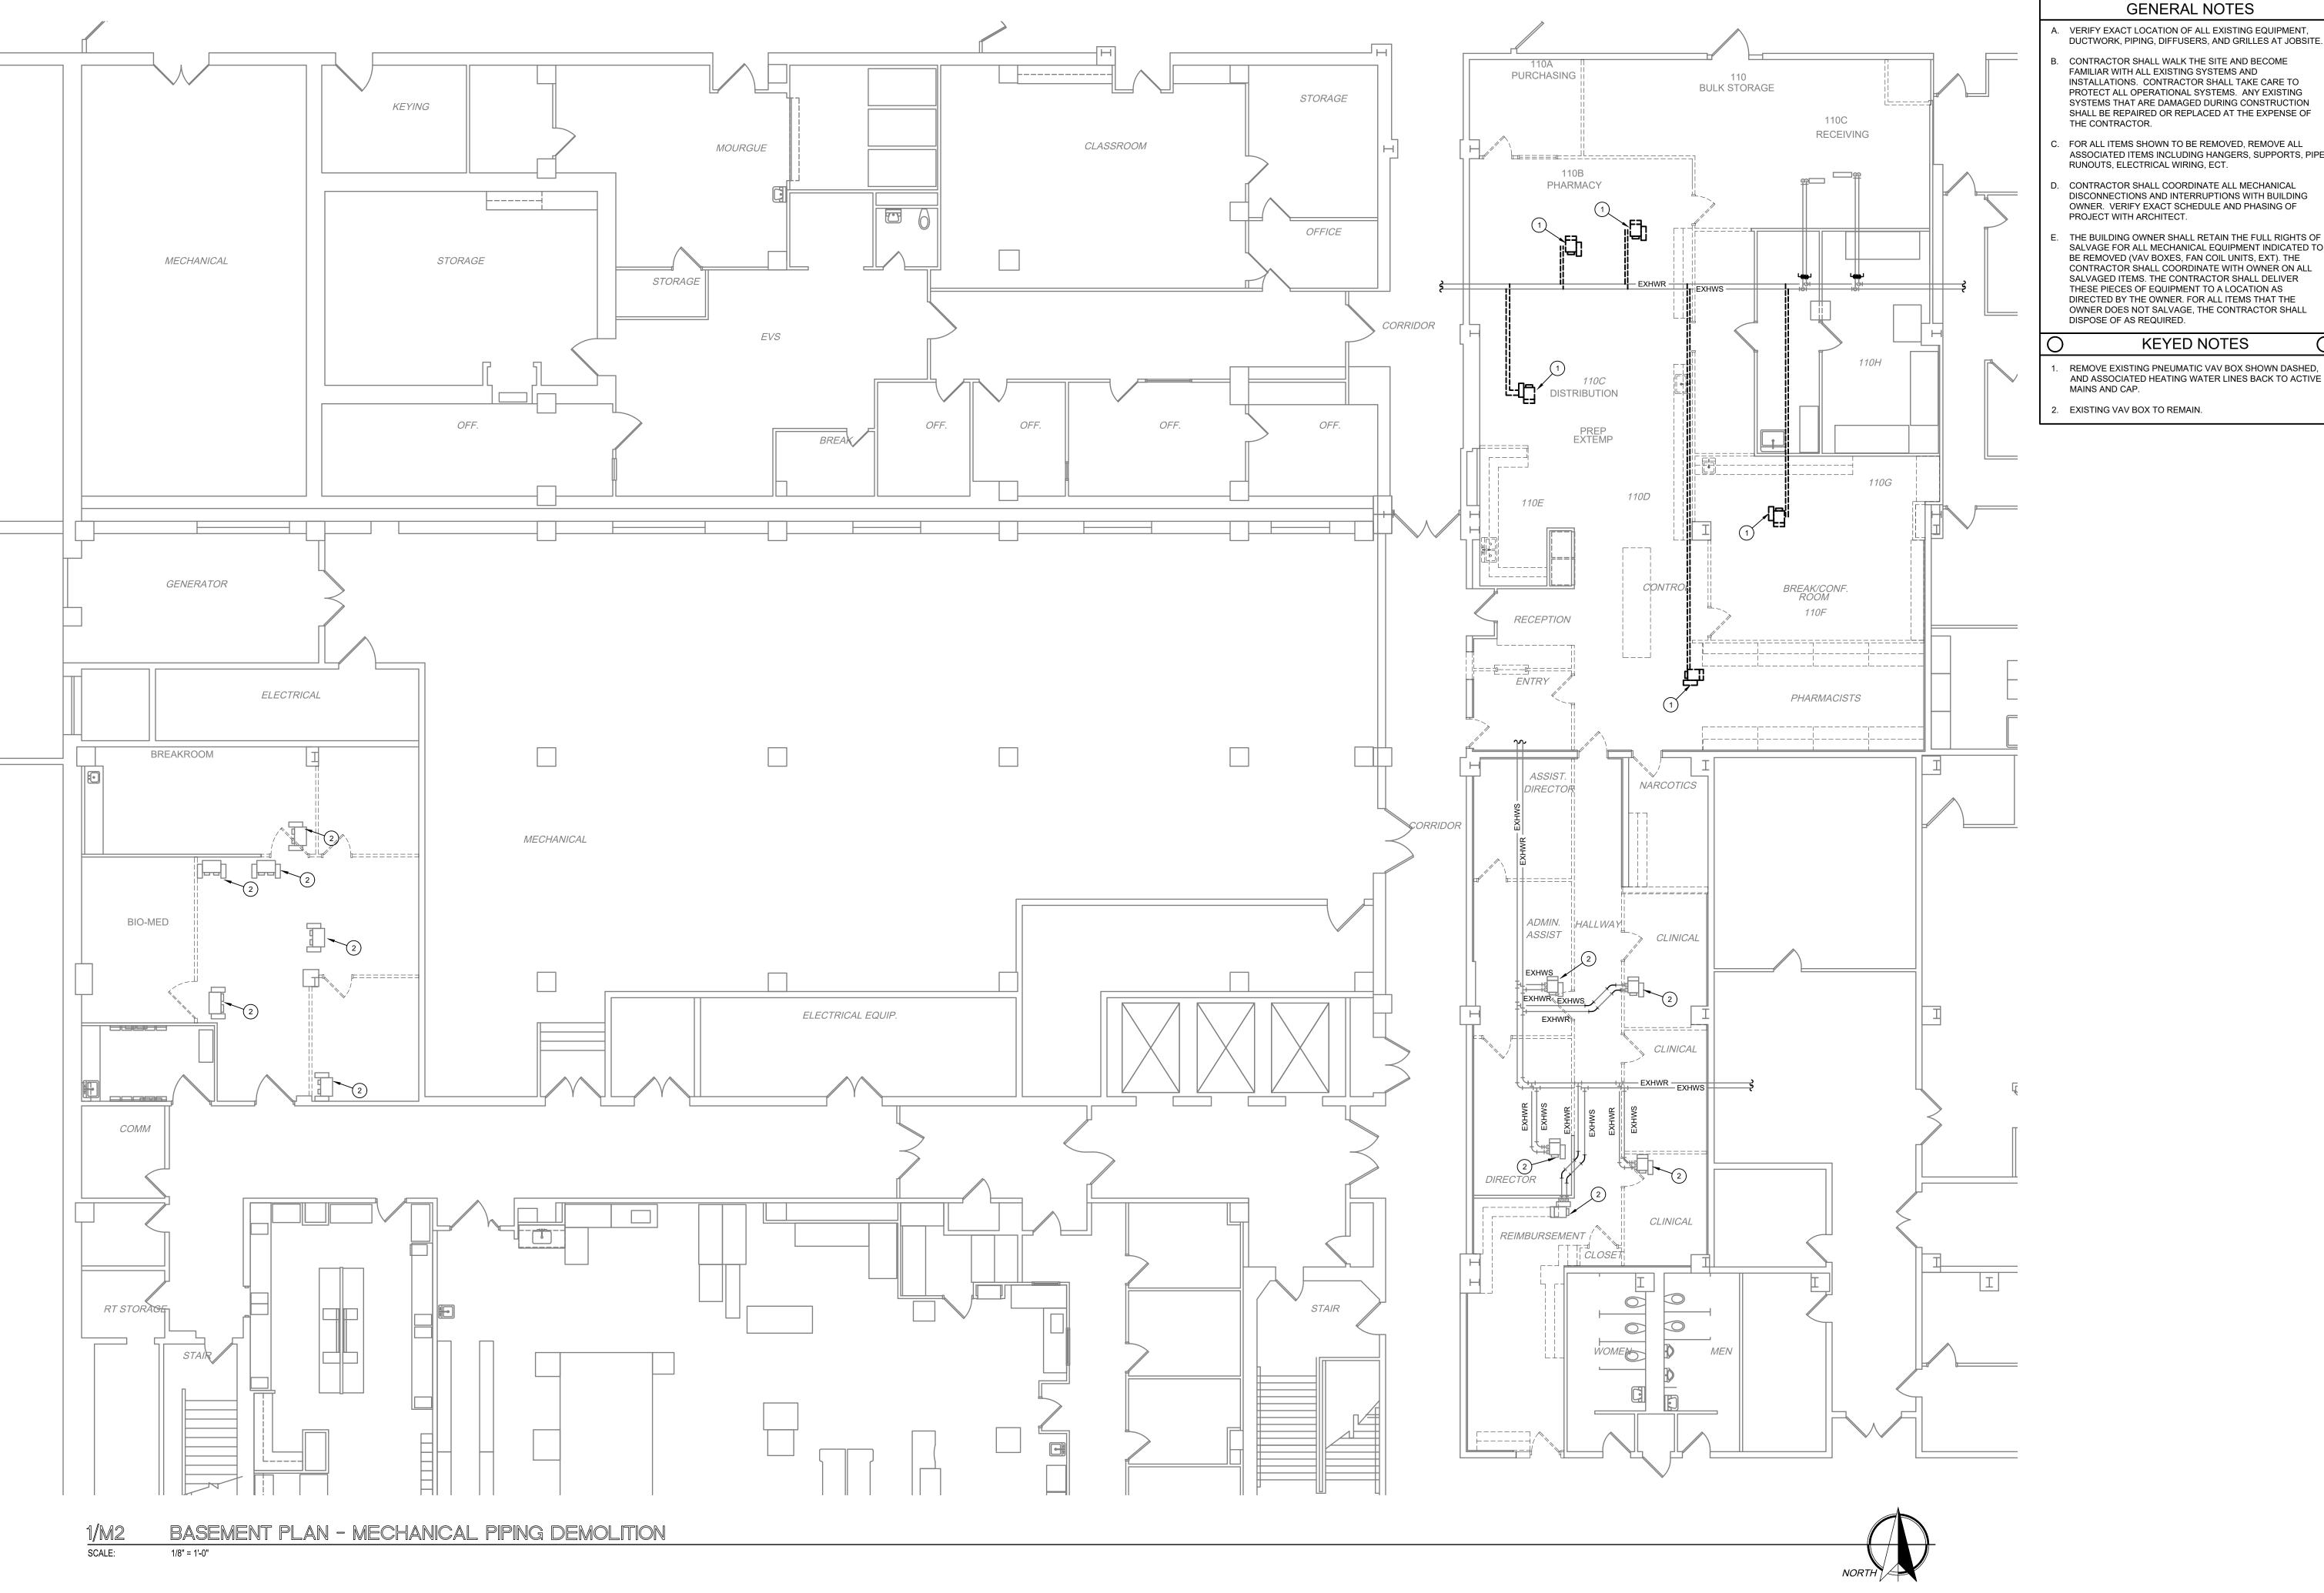
# KEYED NOTES


- REMOVE EXISTING PNEUMATIC VAV BOX SHOWN DASHED, AND ASSOCIATED HEATING WATER LINES BACK TO ACTIVE MAINS AND CAP.
- 2. EXISTING VAV BOX TO REMAIN.



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FINCHER ENGINEERING, LLC TX FIRM #F-16408 5621 114TH ST., SUITE 100 LUBBOCK, TX 79424 PH: 806-701-5109 WWW.FINCHERENG.COM


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PROPOSAL ITEM #1

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PROJECT NO. 04/02/2025

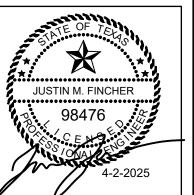SHEET NO. 2 OF 5



BASEMENT PLAN - MECHANICAL

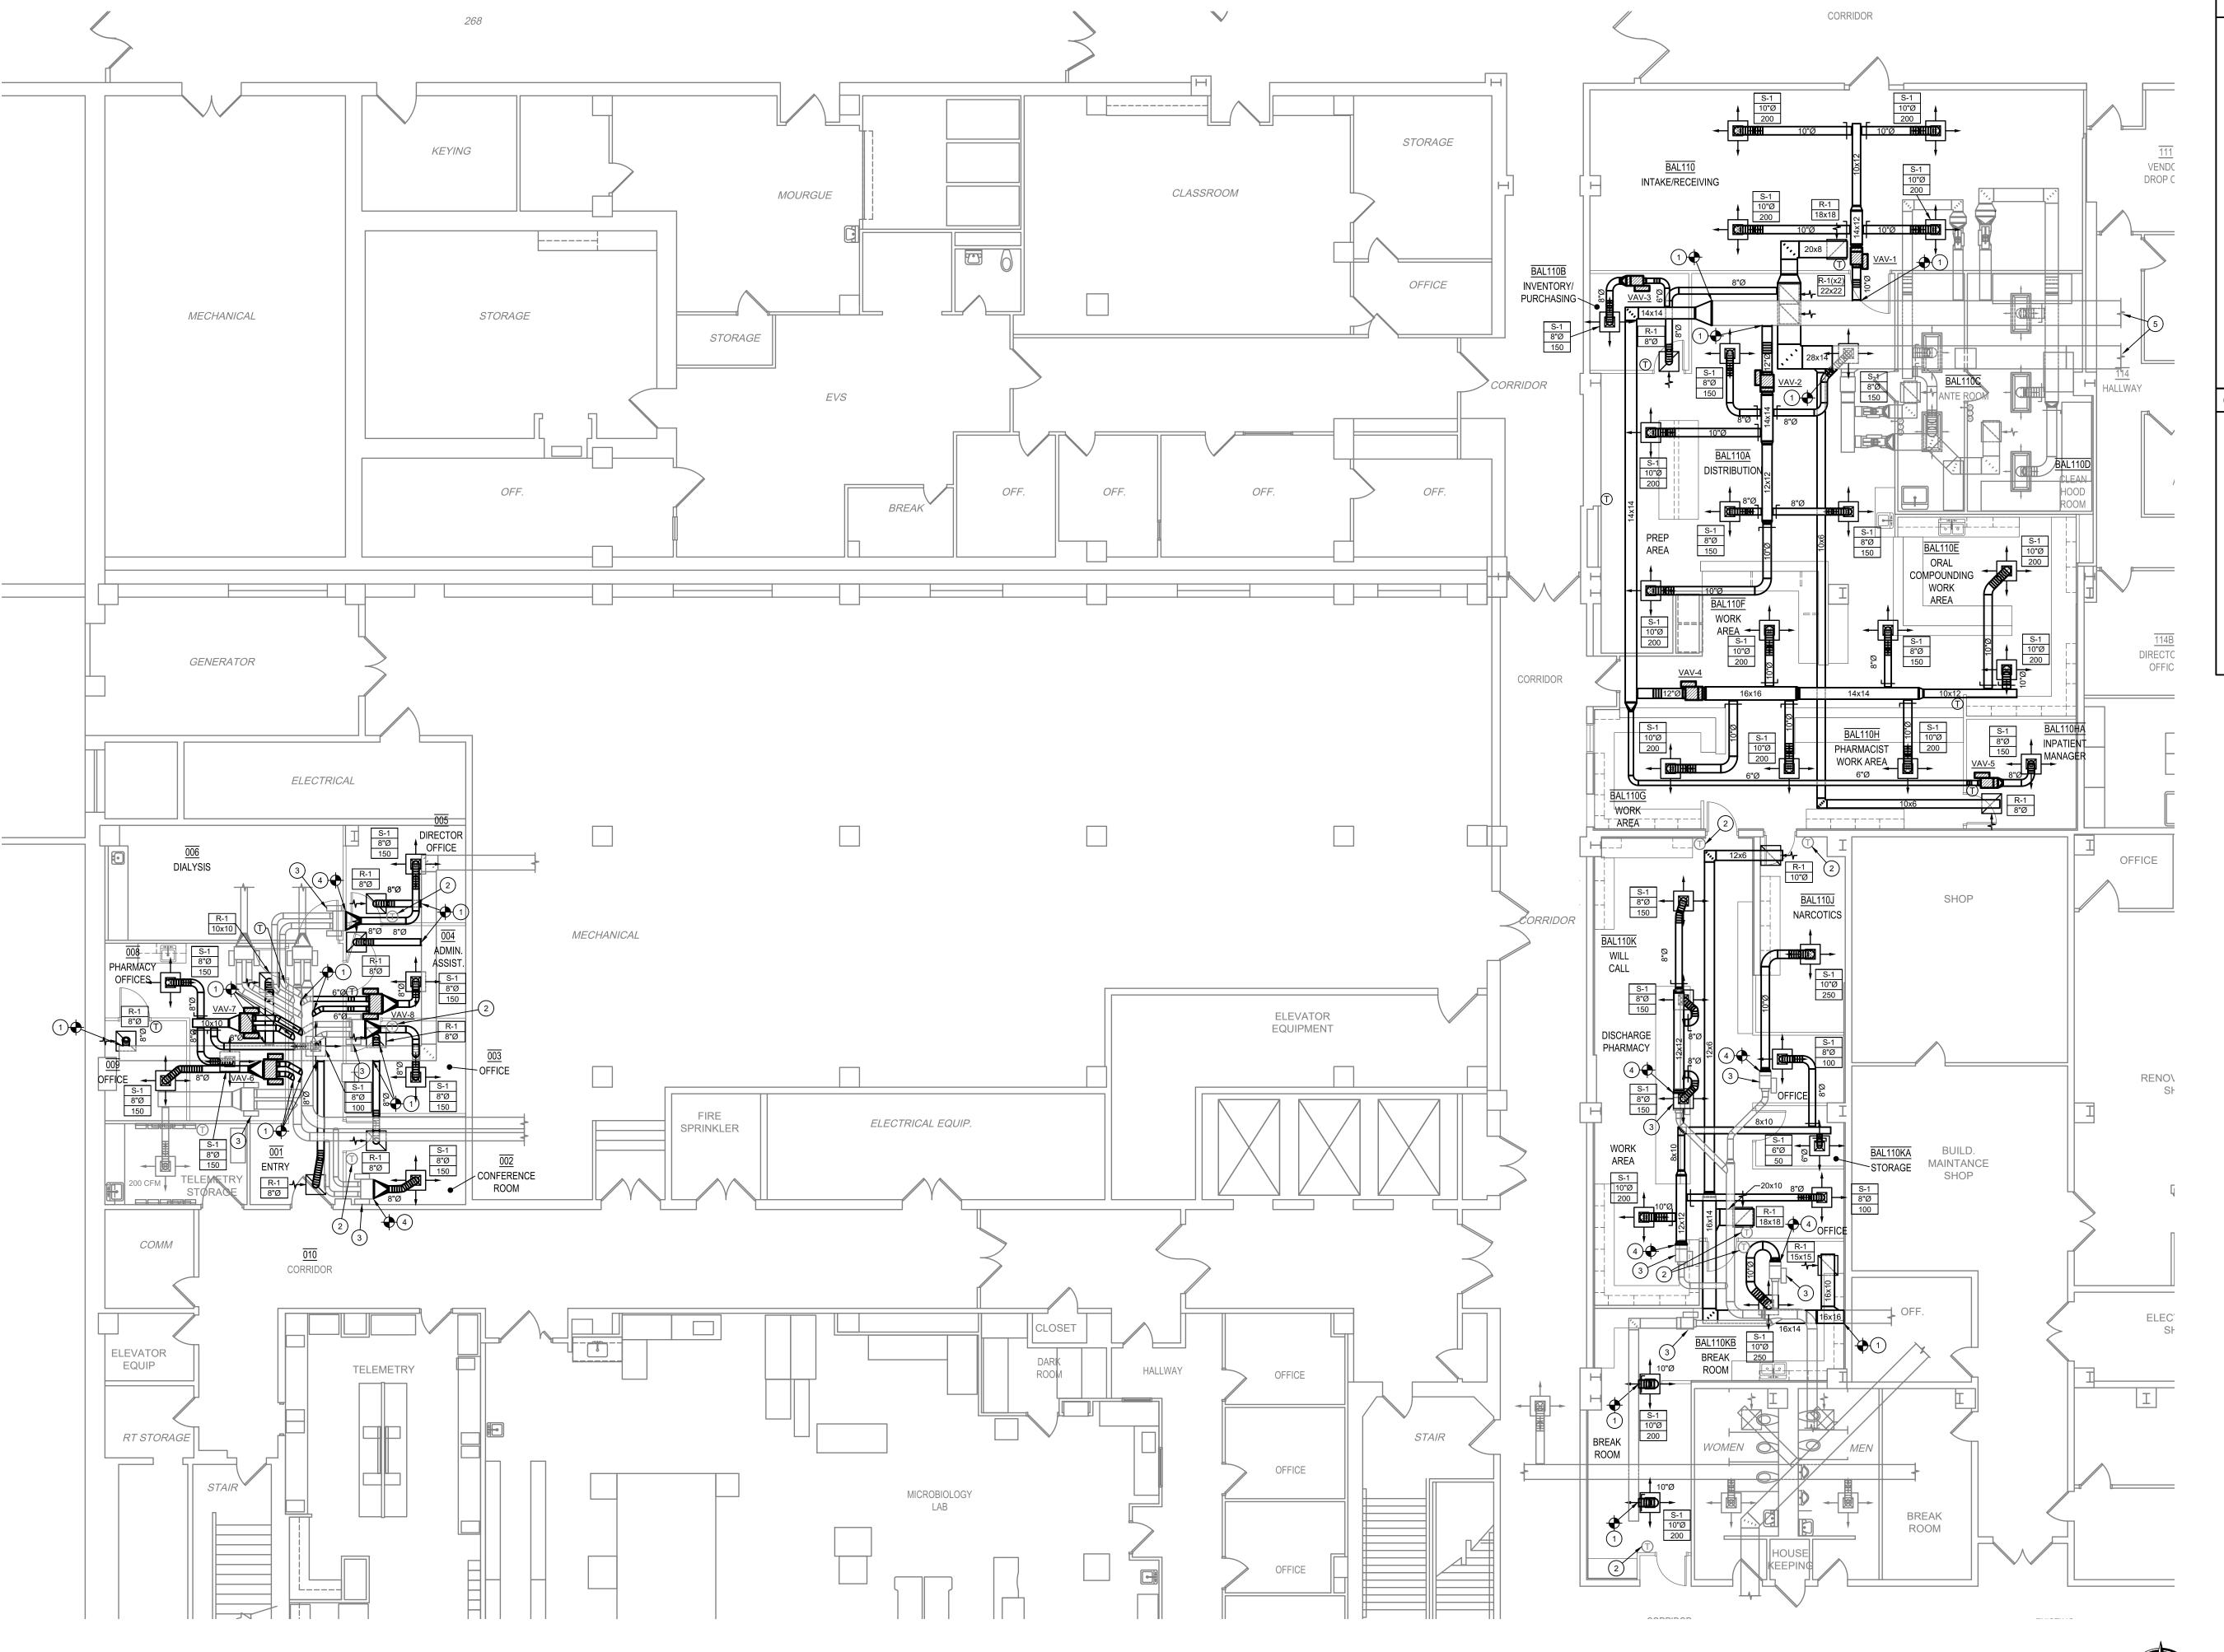1/8" = 1'-0"

#### **GENERAL NOTES**

- VERIFY EXACT LOCATION OF ALL EXISTING EQUIPMENT, DUCTWORK, PIPING, DIFFUSERS, AND GRILLES AT JOBSITE.
- 3. CONTRACTOR SHALL WALK THE SITE AND BECOME FAMILIAR WITH ALL EXISTING SYSTEMS AND INSTALLATIONS. CONTRACTOR SHALL TAKE CARE TO PROTECT ALL OPERATIONAL SYSTEMS. ANY EXISTING SYSTEMS THAT ARE DAMAGED DURING CONSTRUCTION SHALL BE REPAIRED OR REPLACED AT THE EXPENSE OF

THE CONTRACTOR.

- CONTRACTOR SHALL COORDINATE ALL MECHANICAL DISCONNECTIONS AND INTERRUPTIONS WITH BUILDING OWNER. VERIFY EXACT SCHEDULE AND PHASING OF PROJECT WITH ARCHITECT.
- REFER TO ARCHITECTURAL REFLECTED CEILING PLAN FOR LOCATION OF ALL CEILING MOUNTED AIR DISTRIBUTION
- . LOCATE ALL THERMOSTATS A MINIMUM OF SIX INCHES FROM WALL CORNERS, DOOR FRAMES AND OTHER DEVICES. MOUNT THERMOSTATS AT 48" AFF COORDINATE THE LOCATION OF ALL THERMOSTATS WITH ARCHITECT PRIOR TO INSTALLATION.
- CONTRACTOR SHALL FIELD VERIFY EXACT ROUTING OF NEW DUCTWORK AT JOBSITE WITH ALL EXISTING CONDITIONS PRIOR TO DUCT FABRICATION. ROUTE DUCT AS REQUIRED, PROVIDE OFFSETS AS REQUIRED, AND CHANGE DUCT SIZES IF REQUIRED WHILE MAINTAINING EQUAL DUCT FREE AREA.

#### **KEYED NOTES**


- CONNECT NEW DUCTWORK TO EXISTING DUCTWORK AT APPROXIMATELY THIS LOCATION. PROVIDE TRANSITION AS REQUIRED.
- NEW LOCATION FOR EXISTING THERMOSTAT. EXTEND OR MODIFY EXISTING CONTROL WIRING AS REQUIRED.
- EXISTING VAV BOX, RE-BALANCE MAXIMUM AIRFLOW TO TOTAL CONNECTED CFM LISTED ON PLANS. RE-BALANCE MINIMUM CFM TO HALF OF MAXIMUM.
- CONNECT NEW SUPPLY DUCTWORK TO OUTLET OF EXISTING VAV BOX, PROVIDE TRANSITION AS REQUIRED.
- SUPPLY AND RETURN DUCTS SERVED FROM EXISTING AHU-BL01 LOCATED IN BASEMENT INTERSTITIAL SPACE OVER STERILE PROCESSING DEPARTMENT. CONTRACTOR SHALL RE-BALANCE UNIT TO 5450 CFM SUPPLY MAXIMUM, 2725 CFM SUPPLY MINIMUM, 2000 CFM OUTSIDE AIR, AND 50°F LEAVING AIR TEMPERATURE. JOHNSON CONTROLS TO UPGRADE EXISTING AIR HANDLING CONTROLS AS REQUIRED.



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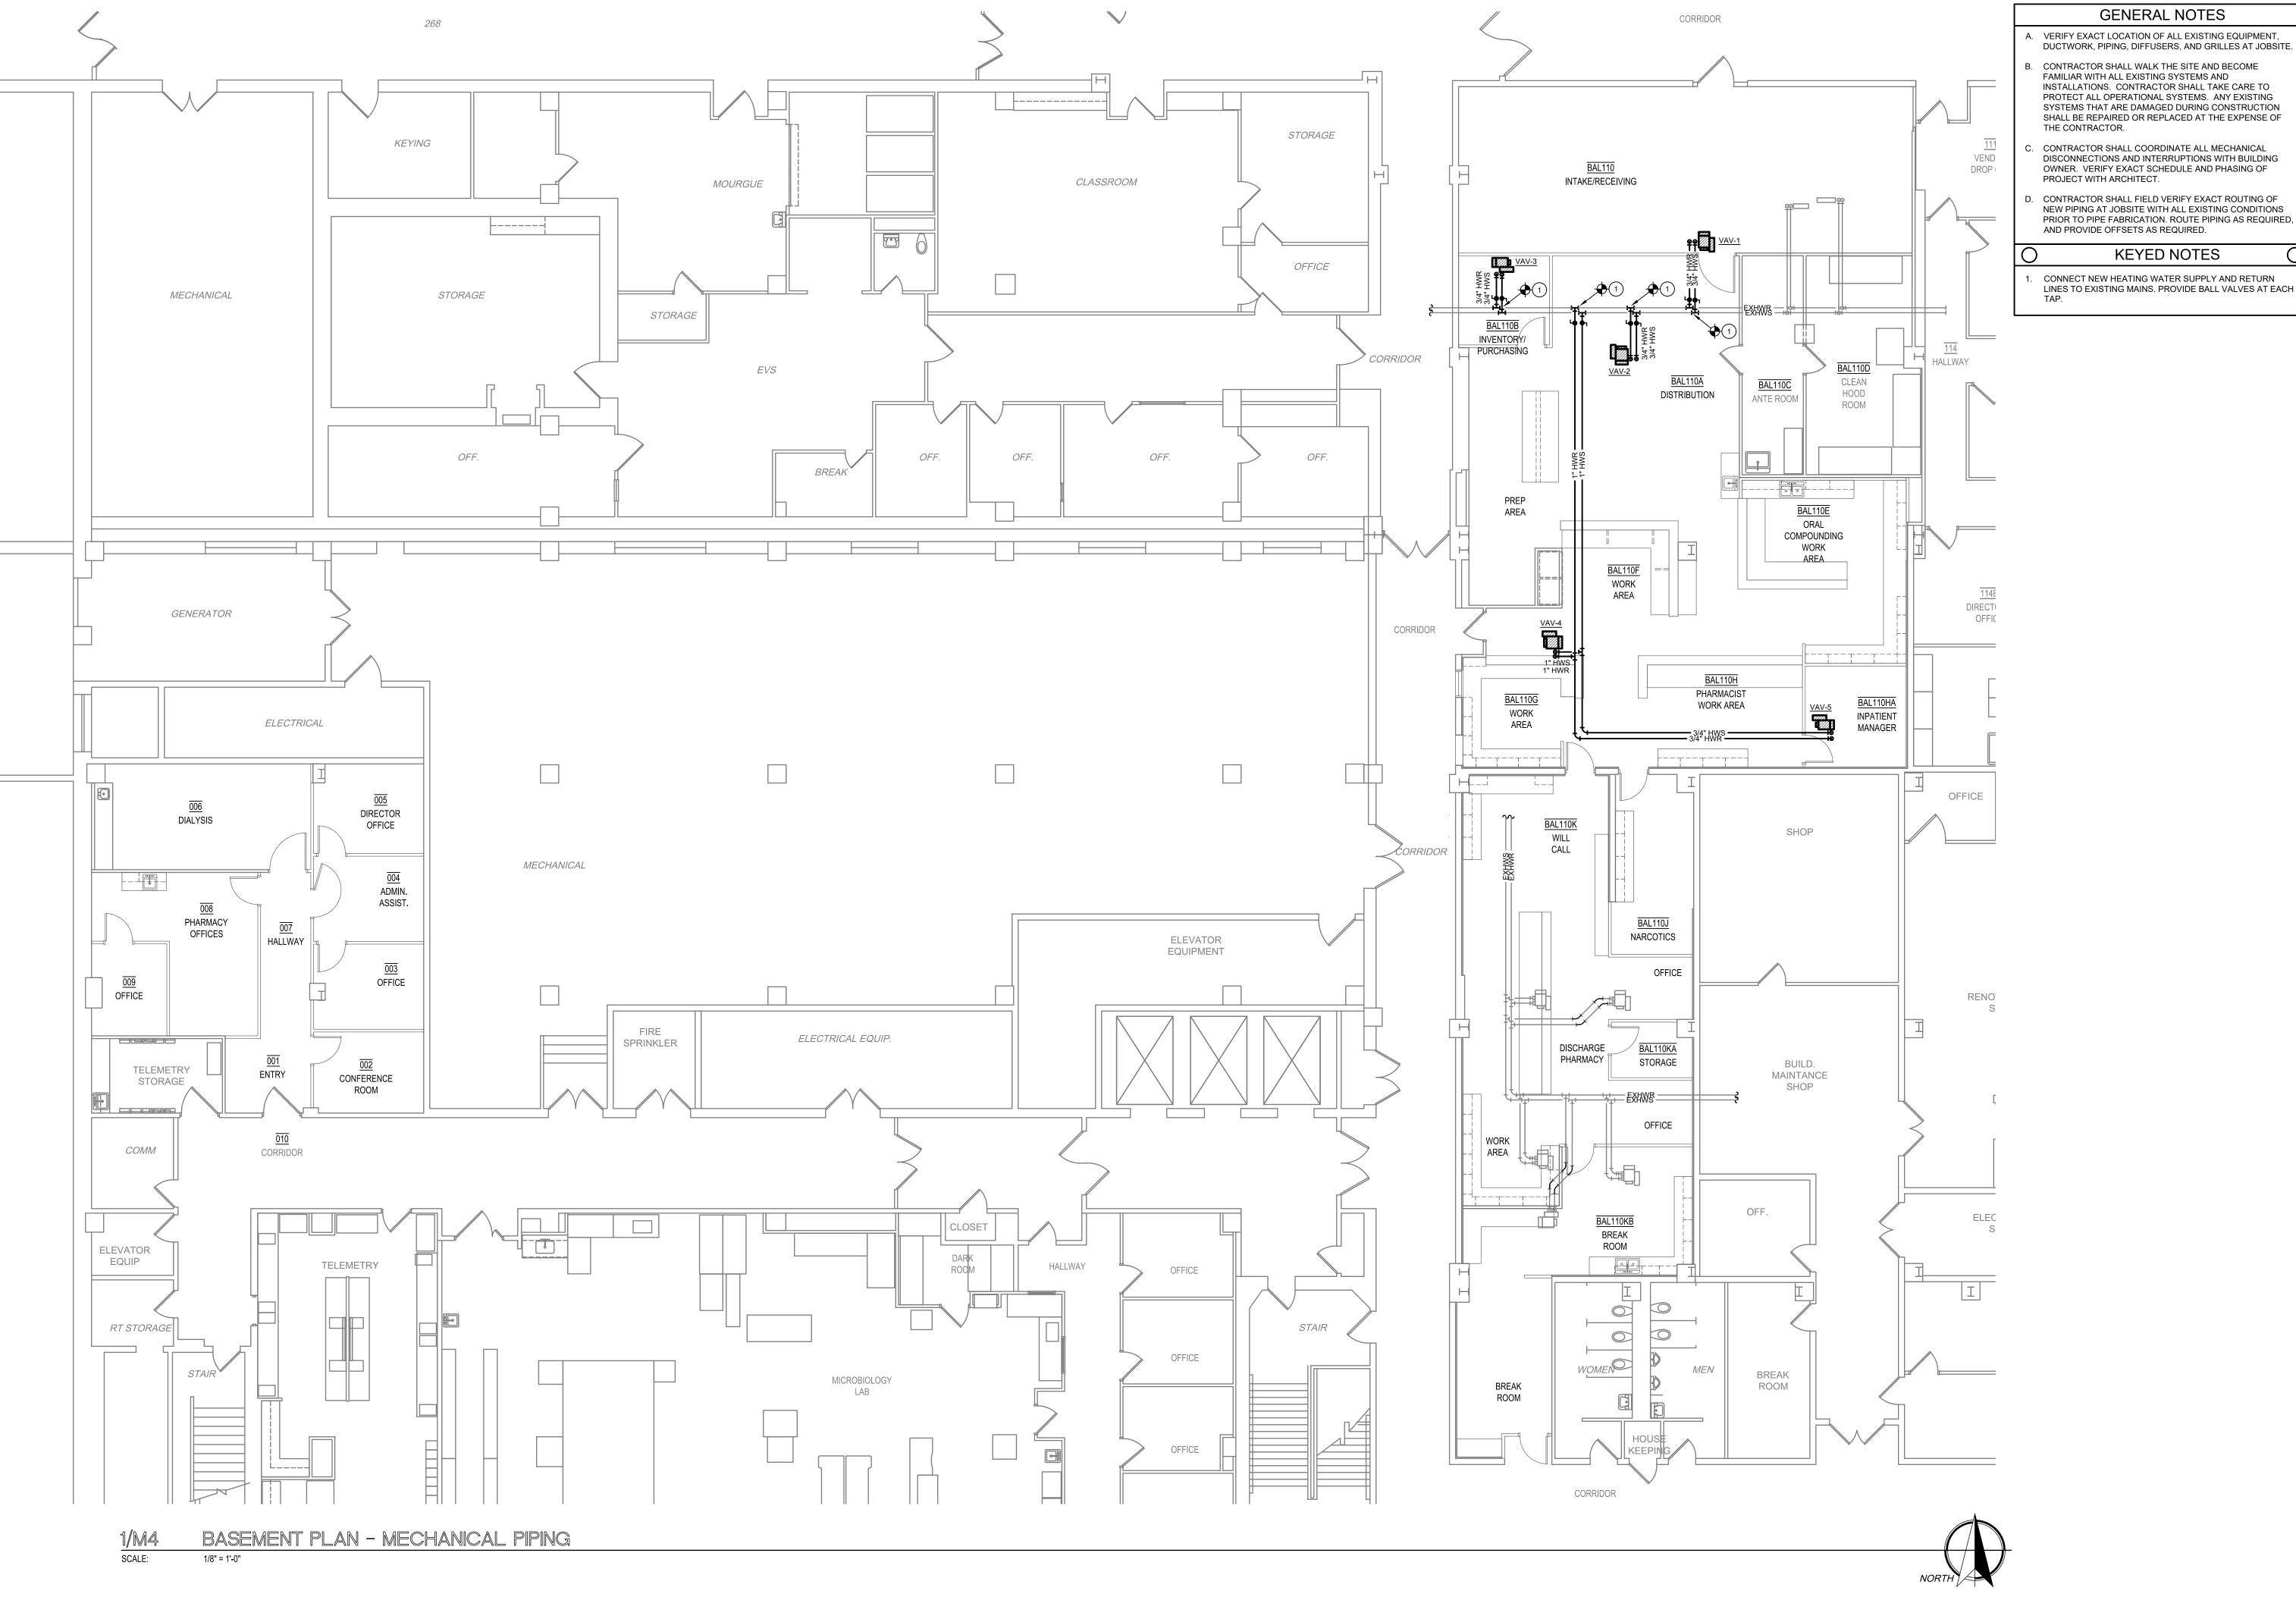
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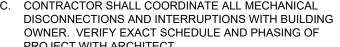
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B. CONTRACTOR SHALL WALK THE SITE AND BECOME INSTALLATIONS. CONTRACTOR SHALL TAKE CARE TO PROTECT ALL OPERATIONAL SYSTEMS. ANY EXISTING SYSTEMS THAT ARE DAMAGED DURING CONSTRUCTION SHALL BE REPAIRED OR REPLACED AT THE EXPENSE OF



CONTRACTOR SHALL FIELD VERIFY EXACT ROUTING OF NEW PIPING AT JOBSITE WITH ALL EXISTING CONDITIONS PRIOR TO PIPE FABRICATION. ROUTE PIPING AS REQUIRED,

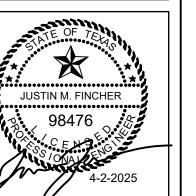CONNECT NEW HEATING WATER SUPPLY AND RETURN LINES TO EXISTING MAINS. PROVIDE BALL VALVES AT EACH



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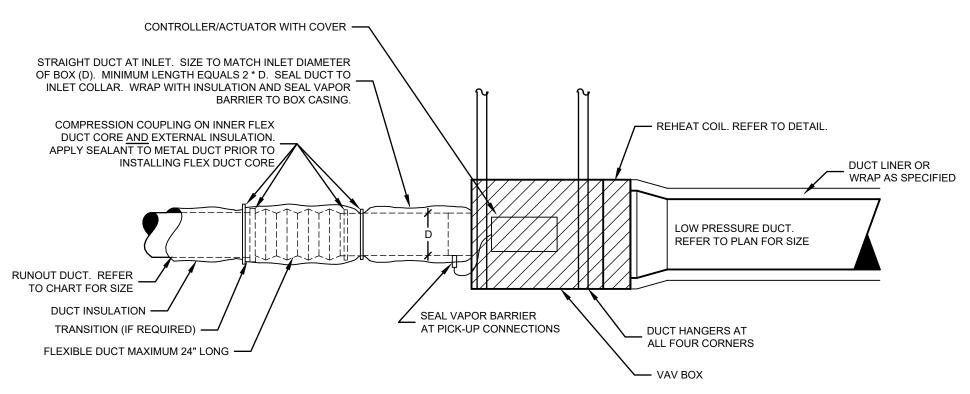
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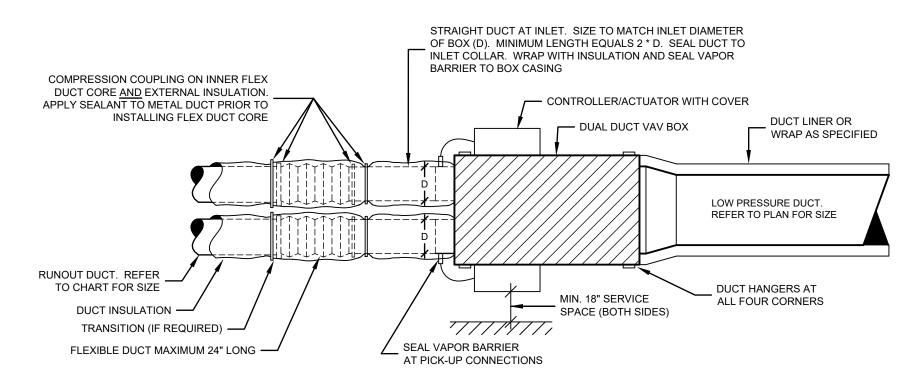
PROJECT NO. 04/02/2025

SHEET NO.



# SINGLE DUCT VAV BOX WITH REHEAT COIL DETAIL

NOTE: PROVIDE MINIMUM OF 18" SERVICE SPACE MEASURED FROM CONTROLLER COVER. SPACE SHALL BE MINIMUM OF 24" WIDE IN DIRECTION OF AIRFLOW.



# DUAL DUCT VAV BOX DUCT CONNECTION DETAIL

NOTE: SERVICE SPACE AT CONTROLLER SHALL BE MINIMUM OF 24" WIDE IN DIRECTION OF AIRFLOW

MARK	MAX CFM	HEATING	MIN. CFM	ESP	INLET		EXAMPLE							
IVIARK	IVIAX CFIVI	MAX CFM	IVIIIN. CEIVI	LOF	SIZE	CAP. (MBH)	GPM	EAT / LAT	EWT / LWT					
VAV-1	800	400	400	0.4"	10"Ø	17.3	1.7	55°F / 95°F	180°F / 160°F	TITUS DESV				
VAV-2	1000	500	500	0.4"	12"Ø	21.6	2.2	55°F / 95°F	180°F / 160°F	TITUS DESV				
VAV-3	150	75	75	0.4"	6"Ø	3.2	0.3	55°F / 95°F	180°F / 160°F	TITUS DESV				
VAV-4	1350	675	675	0.4"	12"Ø	29.2	2.9	55°F / 95°F	180°F / 160°F	TITUS DESV				
VAV-5	150	75	75	0.4"	6"Ø	3.2	0.3	55°F / 95°F	180°F / 160°F	TITUS DESV				
2. PRO\ 3. INLET	NOTES:  1. IF REQUIRED, CONTRACTOR TO PROVIDE TRANSITION FROM DUCT SIZE SHOWN ON PLANS TO SCHEDULED BOX SIZE.  2. PROVIDE ALL VAV BOXES WITH TITUS 'STERILOC' LINER.  3. INLET DUCT SIZE SHALL MATCH SCHEDULED VAV BOX SIZE UNLESS NOTED OTHERWISE ON PLANS WITH 6"Ø BEING MINIMUM DUCT SIZE.  ALL CONTROLS AND CONTROLS TRANSFORMER SHALL BE FACTORY MOUNTED. VAV BOX MANUFACTURER SHALL COORDINATE ALL PRIOR TO BID.													
			VAV B	OX SC	HEDU	LE (DUAL	DUCT							
MADIC	COOLING M	IAX HEATING	MAX MINI	MUM	COLD INL	ET HOT INL	ET	FOD	EVANDLE					

VAV BOX SCHEDULE (SINGLE DUCT WITH HOT WATER COIL)

MARK	COOLING MAX CFM	HEATING MAX CFM	MINIMUM CFM	COLD INLET SIZE	HOT INLET SIZE	ESP	EXAMPLE
VAV-6	150	75	75	6"Ø	6"Ø	0.4"	TITUS DEDV
VAV-7	400	200	200	7"Ø	6"Ø	0.4"	TITUS DEDV
VAV-8	150	75	75	6"Ø	6"Ø	0.4"	TITUS DEDV

1. IF REQUIRED, CONTRACTOR TO PROVIDE TRANSITION FROM DUCT SIZE SHOWN ON PLANS TO SCHEDULED BOX SIZE. 2. PROVIDE ALL VAV BOXES WITH TITUS 'STERILOC' LINER.

3. INLET DUCT SIZE SHALL MATCH SCHEDULED VAV BOX SIZE UNLESS NOTED OTHERWISE ON PLANS WITH 6"Ø BEING MINIMUM DUCT SIZE.


	AIR DISTRIBUTION SCHEDULE													
MARK	TYPE	LOCATION	FRAME	FINISH	MATERIAL	EXAMPLE								
S-2	SUPPLY	CEILING	ТВ	WHITE	STEEL	TITUS TDC, 24x24								
R-1	RETURN	CEILING	ТВ	WHITE	STEEL	TITUS PAR, 24x24								
T-1	TRANSFER	CEILING	ТВ	WHITE	STEEL	TITUS PAR, 24x24								

1. OBD = OPPOSED BLADE DAMPER 2. EXT = EXTRACTOR 3. PF = PLASTER FRAME

4. TB = LAY-IN T-BAR 5. SM = SURFACE MOUNT

1" IN 4" MAXIMUM SLOPE 1" IN 7" DESIRABLE SLOPE	RETURN/EXHAUST DUCT SEE PLAN FOR SIZE
MANUAL BALANCING DAMPER	S.S. SCREW CLAMP (TYP)  SPIN-IN DUCT TAP  FLEX. DUCT  SQUARE TO ROUND  TRANSITION  RETURN/EXHAUST GRILLE
ANGLE TAP DETAIL  NO SCALE	TYPICAL RETURN/EXHAUST GRILLE CONNECTION DETAIL  NO SCALE  NOTE: CONNECTIONS OF FLEX DUCT INNER CORE SHALL BE MADE WITH S.S. WORM DRIVE CLAMPS. OUTER INSULATION SHALL BE FITTED OVER CORE CONNECTION AND SECURED WITH S.S. CLAMP.

NOTE: CONNECTIONS OF FLEX DUCT INNER CORE
SHALL BE MADE WITH S.S. WORM DRIVE CLAMPS.
OUTER INSULATION SHALL BE FITTED OVER
CORE CONNECTION AND SECURED WITH S.S. CLAMP.

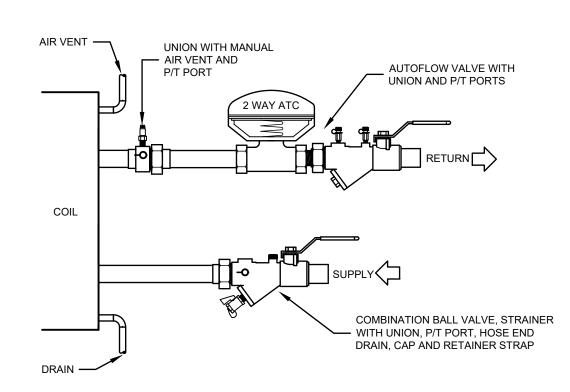

HEATING COIL PIPING DIAGRAM (2-WAY CONTROL) NO SCALE

RECTANGULAR DUCT SEE PLAN FOR SIZE  S.S. SCREW CLAMP (TYP)  SPIN-IN DUCT TAP FLEX. DUCT SQUARE TO ROUND TRANSITION  RETURN AIR GRILLE	INSULATED TRUNK DUCT - SEE PLAN FOR SIZE  ROUND SPIN-IN WITH LOCKING MANUAL VOLUME DAMPER  MAX LENGTH 4 FT.  SUSPEND FROM STRUCTURE  TYPICAL CEILING MOUNTED  SUPPLY DIFFUSER - SEE SCHEDULE FOR TYPE
RETURN AIR GRILLE	
RECTANGULAR RUNOUT DIFFUSER/GRILLE	
CONNECTION DETAIL	SUPPLY AIR DIFFUSER MOUNTING DETAIL

SUPPLY AIR DIFFUSER MOUNTING DETAIL

NOTE: CONNECTIONS OF FLEX DUCT INNER CORE SHALL BE MADE WITH S.S. WORM DRIVE CLAMPS. OUTER INSULATION SHALL BE FITTED OVER

CORE CONNECTION AND SECURED WITH S.S. CLAMP.


AIR DISTRIBUTION TYPE
NECK SIZE

→ AIRFLOW (CFM)

MECHANICAL LEGEND

SYMBOL

DESCRIPTION

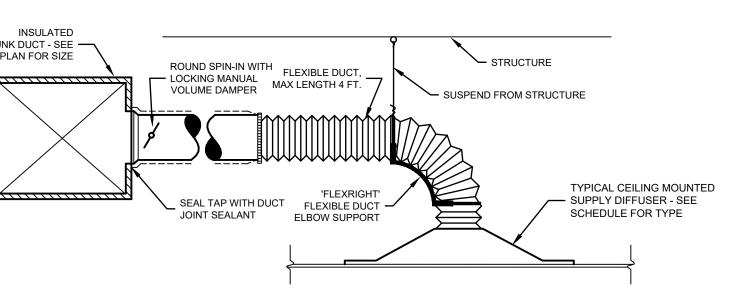

SHEET NO.

04/02/2025

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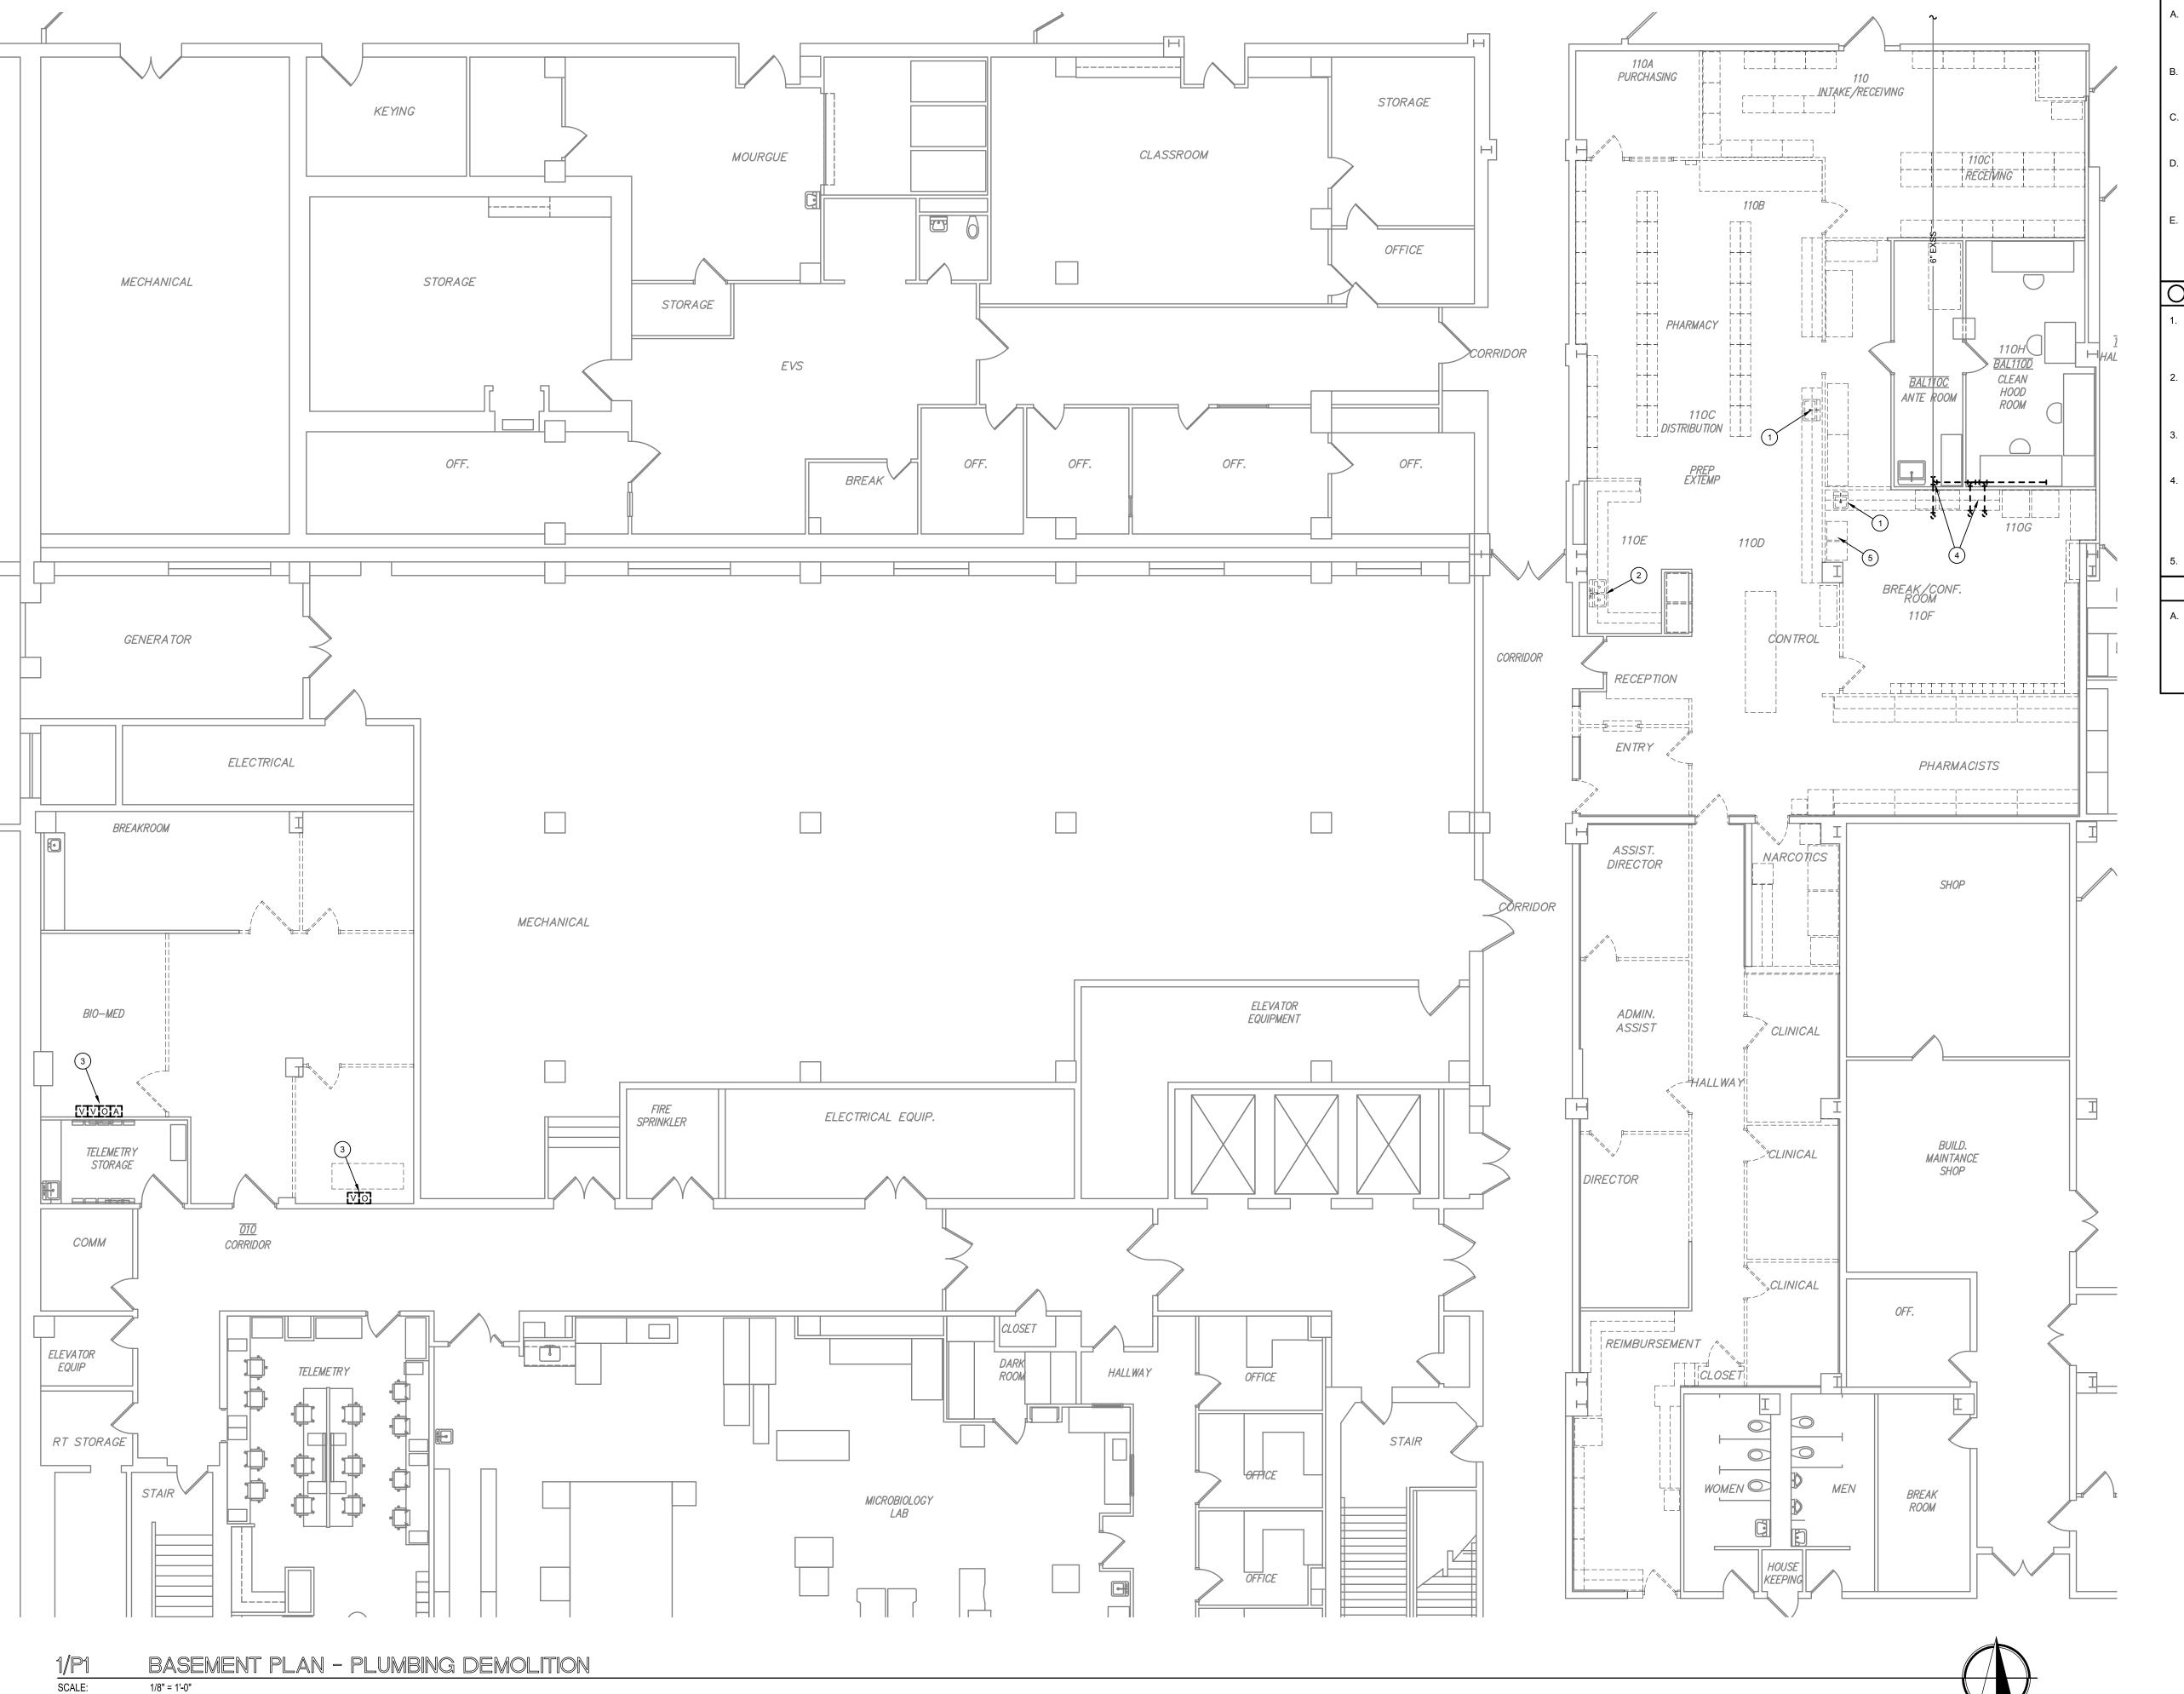
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- A. CONTRACTOR SHALL TAKE CARE TO PROTECT ALL OPERATIONAL SYSTEMS. ANY EXISTING SYSTEMS THAT ARE DAMAGED DURING CONSTRUCTION SHALL BE REPAIRED OR REPLACED AT THE EXPENSE OF THE CONTRACTOR.
  - B. FOR ALL ITEMS SHOWN OR NOTED TO BE REMOVED, REMOVE ALL ASSOCIATED ITEMS INCLUDING ALL HANGERS, INSULATION, VALVES, ETC.
  - E. VERIFY EXACT LOCATION OF ALL EXISTING UTILITIES, PLUMBING FIXTURES, AND PIPING AT THE JOBSITE. CONTRACTOR SHALL FIELD VERIFY EXACT LOCATION OF ALL UTILITIES PRIOR TO BID.
  - D. CONTRACTOR SHALL COORDINATE ALL PLUMBING DISCONNECTIONS AND INTERRUPTIONS WITH BUILDING OWNER. VERIFY EXACT SCHEDULE WITH ARCHITECT AND
  - E. ALL EXISTING MEDICAL GAS PIPING, VALVES, ALARMS TO REMAIN AS EXISTING IN THIS FLOOR. CONTRACTOR SHALL REMOVE AND REPLACE ANY COVER PLATES OR TRIM PLATES AS REQUIRED TO ACCOMMODATE NEW WALL FINISHES, REFER TO ARCHITECTURAL.

#### KEYED NOTES

- REMOVE EXISTING SINK SHOWN DASHED. REMOVE WASTE LINE BACK TO BELOW SLAB AND PLUG. PREPARE VENT, COLD WATER AND HOT WATER LINES AS REQUIRED TO BE EXTEND OVER TO SERVE NEW SINKS IN THIS AREA.
- 2. REMOVE EXISTING SINK SHOWN DASHED. REMOVE EXISTING WATER AND VENT PIPING BACK TO ACTIVE MAINS AND CAP. REMOVE EXISTING SEWER LINE TO BELOW SLAB AND CAP. PATCH FLOOR AS DIRECTED BY ARCHITECT.
- 3. REMOVE EXISTING MEDICAL GAS OUTLETS SHOWN DASHED.
  REMOVE ALL MEDICAL GAS PIPING RUNOUTS BACK TO ACTIVE
  MAINS AND CAP.
- 4. REMOVE THE EXISTING SEWER LINES BELOW SLAB SHOWN DASHED BACK TO POINT SHOWN. THE LINES GOING EAST ARE ABANDONED AND CAN BE REMOVED. THE SECTION OF PIPING SHOWN IS SLIGHTLY BELOW FLOOR OF ANTE ROOM AND HOOD ROOM BUT THOSE ROOMS SHOULD NOT BE DISTURBED AND ALL WORK SHALL BE DONE FROM THE SOUTH SIDE.
- 5. REMOVE ICE MACHINE AND ALL ASSOCIATED PLUMBING SYSTEMS.

#### TTUHSC COORDINATION

A. FOR ALL WORK SHOWN ON TTUHSC SIDE; PRIOR TO COMMENCING EACH STAGE (DEMO, ROUGH-IN, FINAL) OF WORK THE CONTRACTOR SHALL CONTACT ROGER JONES AT TTUHSC TO CONFIRM EXACT SCOPE AND REQUIREMENTS TO CONFIRM ALL INSTALLATIONS MEET REQUIREMENTS OF TTUHSC.




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PROPOSAL ITEM #1

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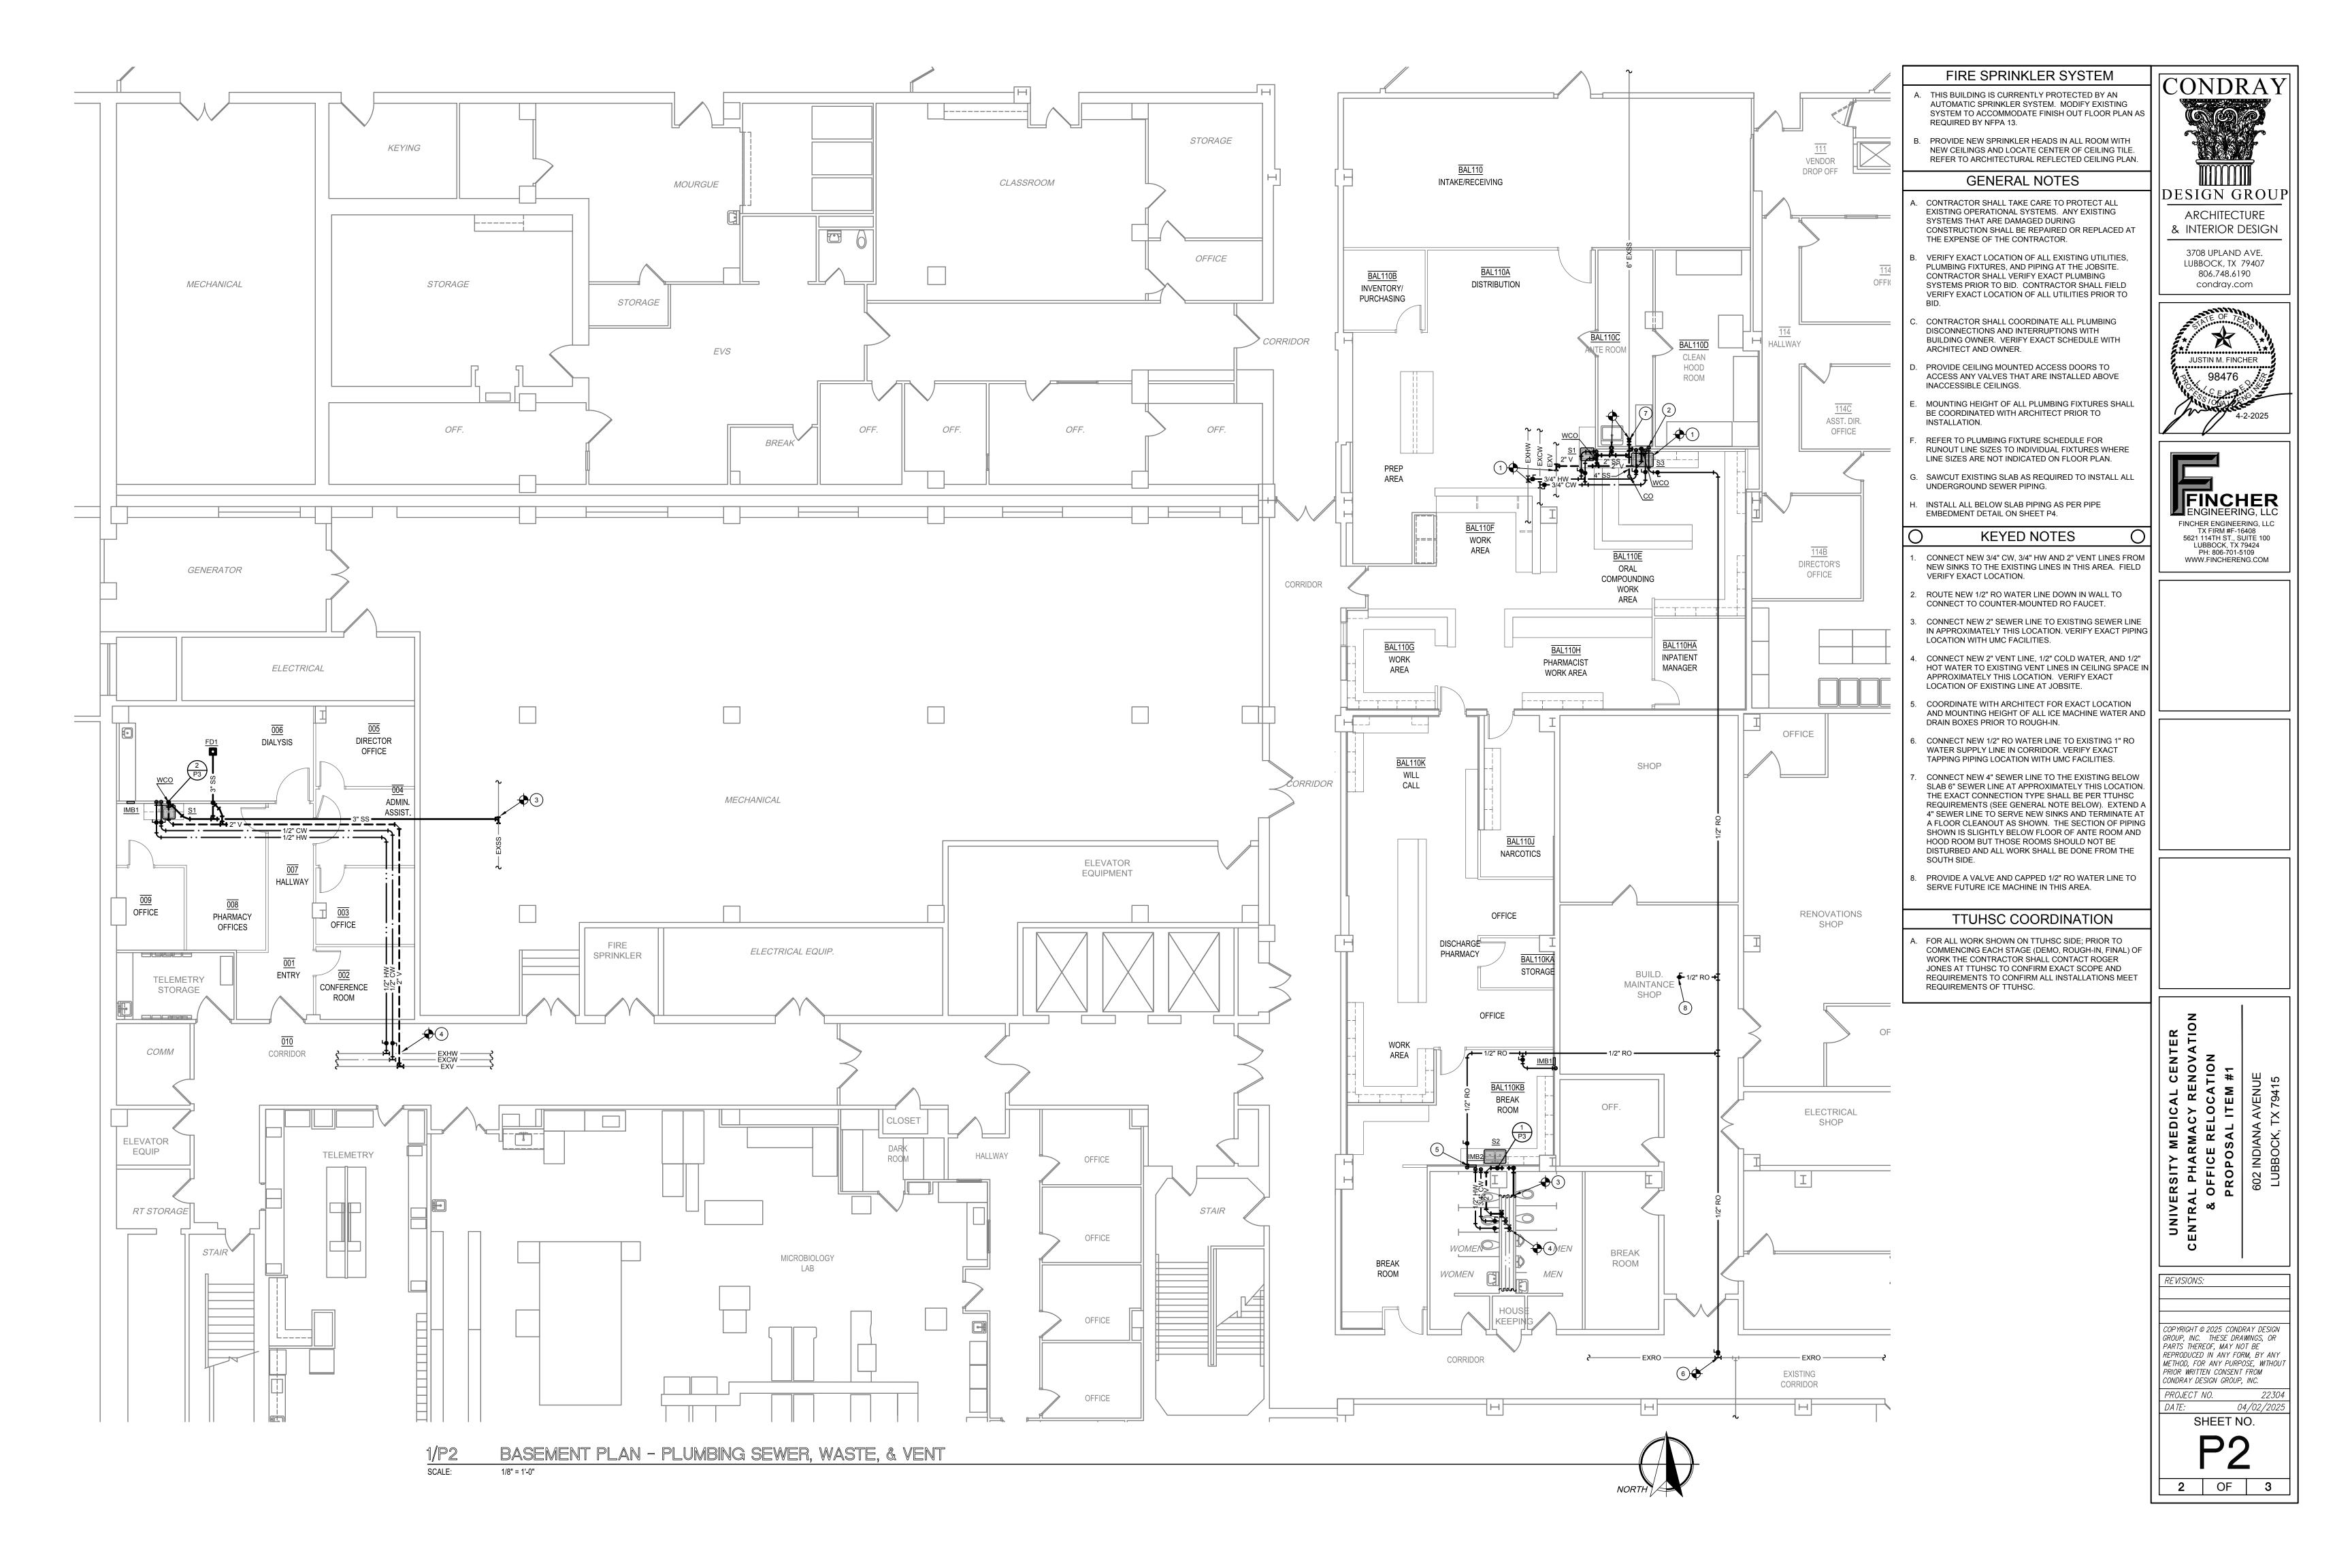
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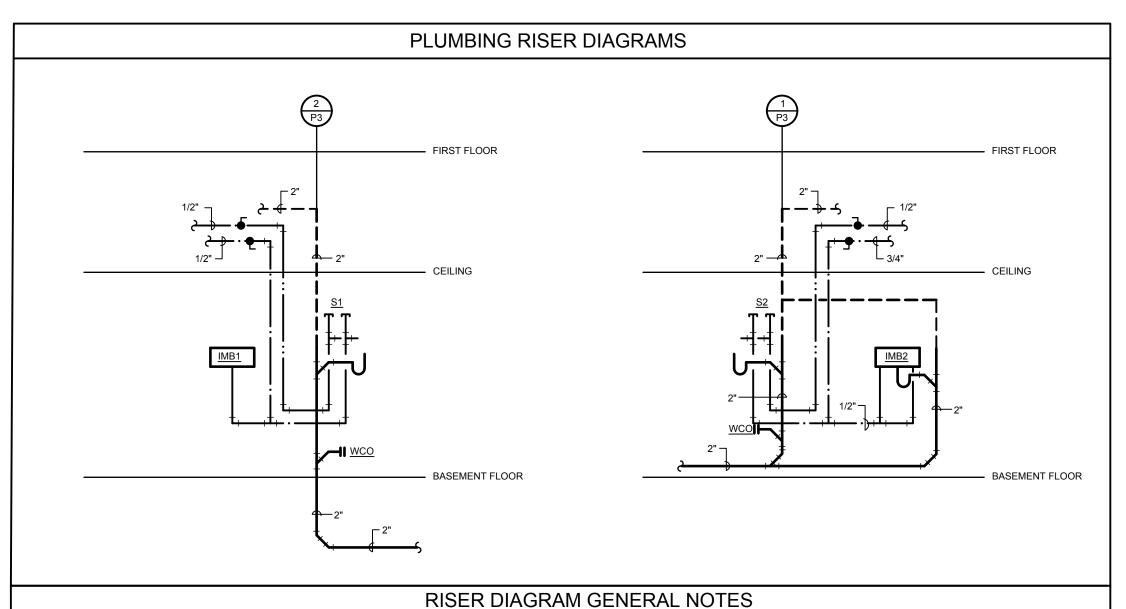
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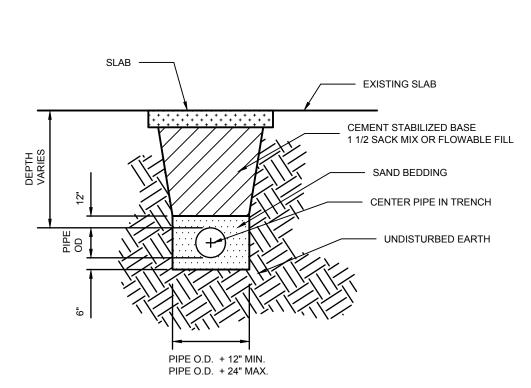
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P1 1 OF 3




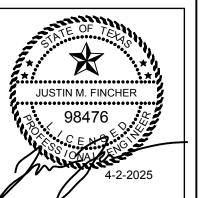

- A. MOUNTING HEIGHT OF ALL PLUMBING FIXTURES SHALL BE COORDINATED WITH ARCHITECT PRIOR TO INSTALLATION.
- B. REFER TO PLUMBING FIXTURE CONNECTION SCHEDULE FOR RUNOUT LINE SIZES TO INDIVIDUAL FIXTURES WHERE LINE SIZES ARE NOT INDICATED ON FLOOR PLAN.
- PROVIDE POINT-OF-USE MIXING VALVE BELOW ALL LAVATORIES AND HAND SINKS AND SET TO PROVIDE MAXIMUM OF 100°F WATER TO HOT WATER SIDE OF ALL FAUCETS. VERIFY MOUNTING LOCATION OF MIXING VALVE WITH OWNER AND WITH ADA CLEARANCE. MIXING VALVE SHALL BE EQUAL TO BRADLEY S59.



BELOW SLAB PIPE EMBEDMENT DETAIL

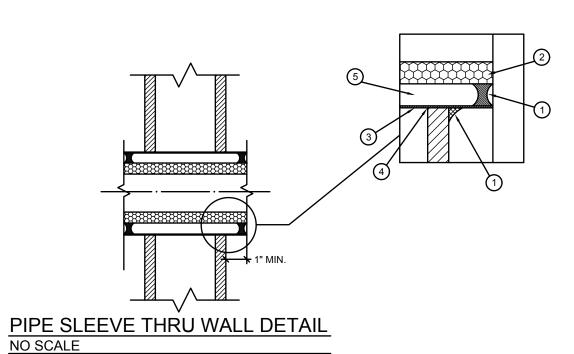

# PIPE SLEEVE THRU WALL DETAIL GENERAL NOTES


1. CAULK CONTINUOUS WITH 3M # 2000 FIRE PROOF 1/2" BEAD (MADE BY 3M COMPANY.)

CONTINUOUS INSULATION THROUGH WALL PENETRATION FOR PIPING THAT REQUIRES

- INSULATION.

  3. 16 GA. PIPE MINIMUM FOR SLEEVES.
- 4. HOLES WILL BE CORED (DRY OR WET NO HAMMER DRILL PENETRATION. PENETRATIONS WILL FIT SNI IG TO SI FEVE
- . MAX. 1/4" ANNULAR SPACE BETWEEN INSULATION AND PIPE FOR NON INSULATED LINES FOR EXAMPLE (AIR, GAS, VAC, ELEC.)

P	PLUMBING LEGEND										
SYMBOL	DESCRIPTION										
	SANITARY SOIL LINE (SS)										
DEMO-XXX	DEMO PLUMBING LINE (XXX = SYSTEM INDICATED)										
	SANITARY VENT LINE (V)										
	COLD WATER LINE (CW)										
	HOT WATER LINE (HW)										
	HOT WATER RETURN LINE (DHC)										
CW	DOMESTIC COLD WATER										
HW	DOMESTIC HOT WATER										
AD	ACCESS DOOR										
SS	SANITARY SOIL										
V	SANITARY VENT										
RO	REVERSE OSMOSIS WATER										
A.F.F.	ABOVE FINISHED FLOOR										
B.F.C.	BELOW FINISHED CEILING										
WCO —⊩	WALL CLEANOUT										
CO o	CLEANOUT										
DCO 👓	DOUBLE CLEANOUT										
<b>-</b>	BALL VALVE										
<del></del>	ELBOW TURNED DOWN										
<del></del>	ELBOW TURNED UP										
	FLOW IN DIRECTION OF ARROW										
——————————————————————————————————————	UNION										
<u> </u>	VALVE IN BOX										
N	CHECK VALVE										
<del>_</del>	GAS COCK										
•	CONNECT TO EXISTING										

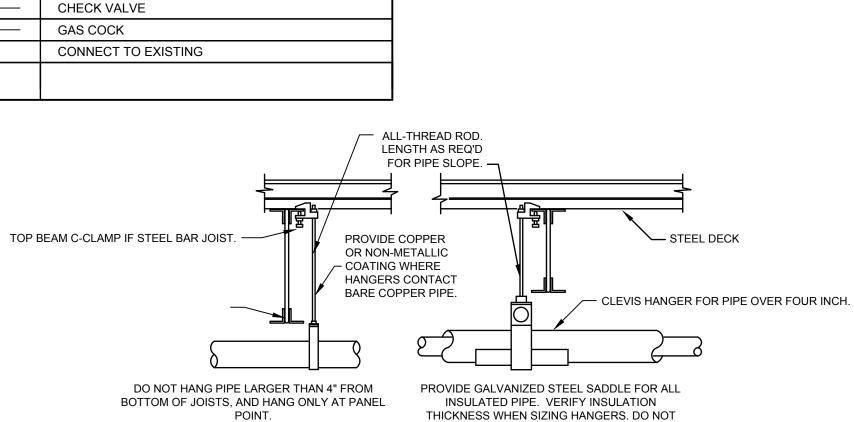

COMMENTS:

1. PROVIDE UPPER ATTACHMENT AS REQUIRED FOR CASES NOT SHOWN HERE. DO NOT INSTALL HANGER INSIDE INSULATION OR OTHERWISE PENETRATE VAPOR BARRIER. DO NOT HANG ONE PIPE FROM ANOTHER EXCEPT IN CHASES. TRAPEZE HANGERS MAY BE USED FOR MULTIPLE PARALLEL PIPES. SLOPE ALL WATER PIPING SLIGHTLY TOWARD DRAINABLE LOCATIONS. HANGER SPACING FOR PIPE SIZE: COPPER: 2"=9'

1½"=8' 1¼"=7' 1"=6' ¾"=6' ¾"=5'. CAST IRON: 10' AND ONE NEAR ALL JOINTS. STEEL: 3"=12' 2½"=11' 2"=10' 1½"=9' 1"=7' ¾"=6' ½"=5'. LOCATE HANGERS AS CLOSE AS POSSIBLE TO TURNS AND TEES OF PIPE. PROVIDE SUPPLEMENTARY STEEL STRUTS BETWEEN JOISTS IF REQUIRED. LOCATE HANGERS TO TAKE LOAD OFF OF EQUIPMENT CONNECTIONS. ANCHOR WATER PIPE AGAINST SWAYING DUE TO CHANGES IN WATER VELOCITY. PROVIDE SEISMIC BRACING AS REQUIRED BY LOCAL AUTHORITIES. CHAINS OR PERFORATED STRAP IRON OR STEEL IS NOT ACCEPTABLE. DO NOT SUSPEND PIPE FROM JOIST BRACING MEMBERS. REFER TO CODES AND SPECIFICATIONS FOR FURTHER INFORMATION.

SUSPEND OTHER ITEMS FROM PIPE.

PIPE HANGER DETAIL
NO SCALE

MARK	FIXTURE SPECIFICATION		XTURE CONNECTIONS RUNOUT LINE SIZES)		
		CW	HW	SS	V
	SINKS				
	Fixture: Elkay LRAD-1918, 19" x 18" x 6" deep, single compartment, off-center drain, 18 gage type 302 self rimming stainless steel with 2 holes. TAS compliant.  Supply: T&S Brass B-2742, single lever side mounted remote on/off contral base faucet, ceramic cartridge, swivel gooseneck, 16" flexible stainless steel supply hoses and 2.2GPM aerator. TAS compliant.	1/2"			
	Strainer: McGuire 1151WC, adjustable brass offset sink strainer with 17 gauge seamless brass waste arm and tailpiece, cast brass slip nuts and heavy cast elbow.				
S1	P-trap: McGuire 8912C-F P-trap shall be chrome plated cast brass body with cleanout, with 17 gauge seamless wall bend, slip nuts and Chrome Plated Forged Brass Set Screw Flange.		1/2"	2"	2"
	Stops, risers: McGuire BV2165-F Supply kit shall include commercial pattern chrome plated Quarter-Turn Brass Ball Valve with convertible loose key handle, Chrome Plated copper riser and Chrome Plated Forged Brass Set Screw Flange.				
	Protective Insulation: Plumberex X4333/X4114, Insulate per ADA 4.19.4 and or IBC all exposed lavatories drain piping, hot/cold stops and supplies. Protectors will consist of molded closed cell PVC, with anti-fungal and anti-microbial properties. To be one piece continuous smooth design.				
	Fixture: Elkay LRAD-3321, 33"x 21-1/4", 5-1/2" deep, double compartment with off-center drain outlets, 18 gage type 304 self rimming stainless steel with 2 holes. TAS Compliant.				
	Supply: T&S Brass B-2742, single lever side mounted remote on/off contral base faucet, ceramic cartridge, swivel gooseneck, 16" flexible stainless steel supply hoses and 2.2GPM aerator. TAS compliant.				
	Strainer: McGuire 1151WC, adjustable brass offset sink strainer with 17 gauge seamless brass waste arm and tailpiece, cast brass slip nuts and heavy cast elbow.				
S2	P-trap: McGuire 8912C-F P-trap shall be chrome plated cast brass body with cleanout, with 17 gauge seamless wall bend, slip nuts and Chrome Plated Forged Brass Set Screw Flange.	1/2"	1/2"	2"	2"
	Stops, risers: McGuire BV2165-F Supply kit shall include commercial pattern chrome plated Quarter-Turn Brass Ball Valve with convertible loose key handle, Chrome Plated copper riser and Chrome Plated Forged Brass Set Screw Flange.				
	Protective Insulation: Plumberex X4333/X4114, Insulate per ADA 4.19.4 and or IBC all exposed lavatories drain piping, hot/cold stops and supplies. Protectors will consist of molded closed cell PVC, with anti-fungal and anti-microbial properties. To be one piece continuous smooth design.				
	Fixture: Elkay LRD-3321, 33"x 21-1/4", 7-7/8" deep, double compartment with off-center drain outlets, 18 gage type 304 self rimming stainless steel with 2 holes.				
	Supply: T&S Brass B-2742, single lever side mounted remote on/off contral base faucet, ceramic cartridge, swivel gooseneck, 16" flexible stainless steel supply hoses and 2.2GPM aerator. TAS compliant. Provide separate RO water faucet, counter-mounted, manufacturered by Tomlinson or equal.				
	RO Water Supply: Provide separate RO water faucet, counter-mounted, manufacturered by Tomlinson or equal.	1/2"			
S3	Strainer: McGuire 1151WC, adjustable brass offset sink strainer with 17 gauge seamless brass waste arm and tailpiece, cast brass slip nuts and heavy cast elbow.	CW &1/2"	1/2"	2"	2"
	P-trap: McGuire 8912C-F P-trap shall be chrome plated cast brass body with cleanout, with 17 gauge seamless wall bend, slip nuts and Chrome Plated Forged Brass Set Screw Flange.	RO			
	Stops, risers: McGuire BV2165-F Supply kit shall include commercial pattern chrome plated Quarter-Turn Brass Ball Valve with convertible loose key handle, Chrome Plated copper riser and Chrome Plated Forged Brass Set Screw Flange.				
	Protective Insulation: Plumberex X4333/X4114, Insulate per ADA 4.19.4 and or IBC all exposed lavatories drain piping, hot/cold stops and supplies. Protectors will consist of molded closed cell PVC, with anti-fungal and anti-microbial properties. To be one piece continuous smooth design.				
	SPECIALTIES				
IMB1	Fixture: Guy Gray SSIB1 stainless steel ice maker box with quarter turn valves.	1/2"			
IMB2	Fixture: Guy Gray SSWB1 stainless steel washer box with quarter turn valves. Provide (2) 1/2" cold water lines from box to supply each nearby peice of equipment requiring water. Route all drain lines from equipment to spill into drain connection.	1/2" (x2)		2"	2"

Fixture: Floor Drains shall be coated cast iron, two piece body, non puncturing flashing collar with weep holes and 6" adjustable satin Nikaloy square strainer equal to Josam 30000-6S. Provide all floor drains with trap seal equal to ProSet Trap Guard and install according

Floor cleanouts in unfinished areas shall be equal to Josam 55000-1-SD with special duty scoriated secured round laminated satin Nikaloy

Floor cleanouts in finished floors shall be equal to Josam 55000-1 with medium-duty scoriated secured round satin Nikaloy Cover.

Floor cleanouts in floors with thin flooring shall be equal to Josam 55000-1-13 with recessed top for flooring.


CLEANOUTS

Floor cleanouts in tiled floors shall be equal to Josam 55000-1-SQ with scoriated secured square satin Nikaloy Cover.

Wall cleanouts shall be concealed behind Stainless Steel access cover with screw equal to Josam 58600.

CO, WCO, Floor cleanouts in carpeted floors shall be equal to Josam 55000-14 with scoriated secured round cover and carpet cleanout marker.

to manufacturer's instructions.

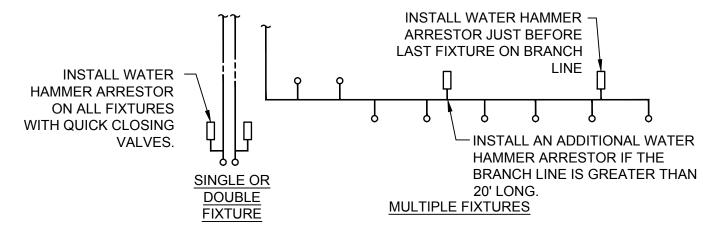

		FIXTUR	<u>E</u>	MOLTIFLE FIXTURES									
PDI	PIPE	FIXTURE		WATER SUPPLY FIXTURE UNIT (WSFU)									
SIZE	SIZE	UNIT LOAD		SIZE UNIT LOAD FIXTURE (									
Α	1/2"	1-11		VALVE WATER CLOSET	5								
В	3/4"	12-32		URINAL	4								
С	1"	33-60		LAVATORY/SINK	1.5	1.5							
D	1-1/4"	61-113		JANITOR'S SINK	3	3							
Е	1-1/2"	114-154											
F	2"	154-330											

# COMMENTS:

1. WATER HAMMER ARRESTERS SHALL BE HAVE PISTON AND 0-RING CONSTRUCTION WITH PDI #WH-201, ASSE # 1010 AND ANSI # A112.26.1M CERTIFICATION. INSTALL IN HORIZONTAL OR VERTICAL POSITION, BUT NEVER UPSIDE DOWN. SIZE THE UNITS AS SHOWN PER THE TABLES SHOWN ABOVE.

WATER HAMMER ARRESTER DETAIL
NO SCALE



& INTERIOR DESIGN

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MEDICAL CENTER
RMACY RENOVATION
E RELOCATION
DSAL ITEM #1
DIANA AVENUE

LINE SIZE UP TO 4"

REVISIONS:


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PROJECT NO. 22304

DATE: 04/02/2025

SHEET NO.



- ALL ELECTRICAL DEVICES SHOWN DASHED, OR ON DASHED WALLS, ALONG WITH ALL WIRING AND CONDUIT ASSOCIATED WITH DEVICE SHALL BE REMOVED BACK TO POINT OF ORIGIN UNLESS NOTED OTHERWISE.
- VERIFY EXACT LOCATION OF ALL DEVICES AND CONDUIT TO
- THE ELECTRICAL CONTRACTOR SHALL FIELD VERIFY EXISTING DEVICES. ALL ABANDONED DEVICES/SYSTEMS AND WIRING SHALL BE DEMOLISHED. DO NOT RELOCATE TO NEW CEILINGS/WALLS.
- ALL DOWNSTREAM DEVICES NOT BEING REMOVED AS PART OF THIS PROJECT SHALL REMAIN ACTIVE. THIS INCLUDES BUT NOT LIMITED TO RECEPTACLES, LIGHTS, FIRE ALARM, DATA, AND COMMUNICATION OUTLETS/WIRING.
- ALL POWER AND COMMUNICATIONS OUTAGES SHALL BE COORDINATED WITH OWNER AND ARCHITECT PRIOR TO OUTAGE. PROVIDE TEMPORARY CONNECTIONS (POWER AND COMMUNICATION WIRING) TO EQUIPMENT TO MAINTAIN SERVICE DURING CONSTRUCTION AS REQUIRED.
- FIRE ALARM WORK FOR UMC SHALL BE PERFORMED BY UMC FIRE ALARM CONTRACTOR(LUBBOCK SOUND). FIRE ALARM WORK FOR TTUHSC SHALL BE PERFORMED BY TTUHSC FIRE ALARM CONTRACTOR(FIREMASTER). COORDINATE CONNECTION OF EXISTING DEVICES WITH FIRE ALARM CONTRACTOR AND MANUFACTURER

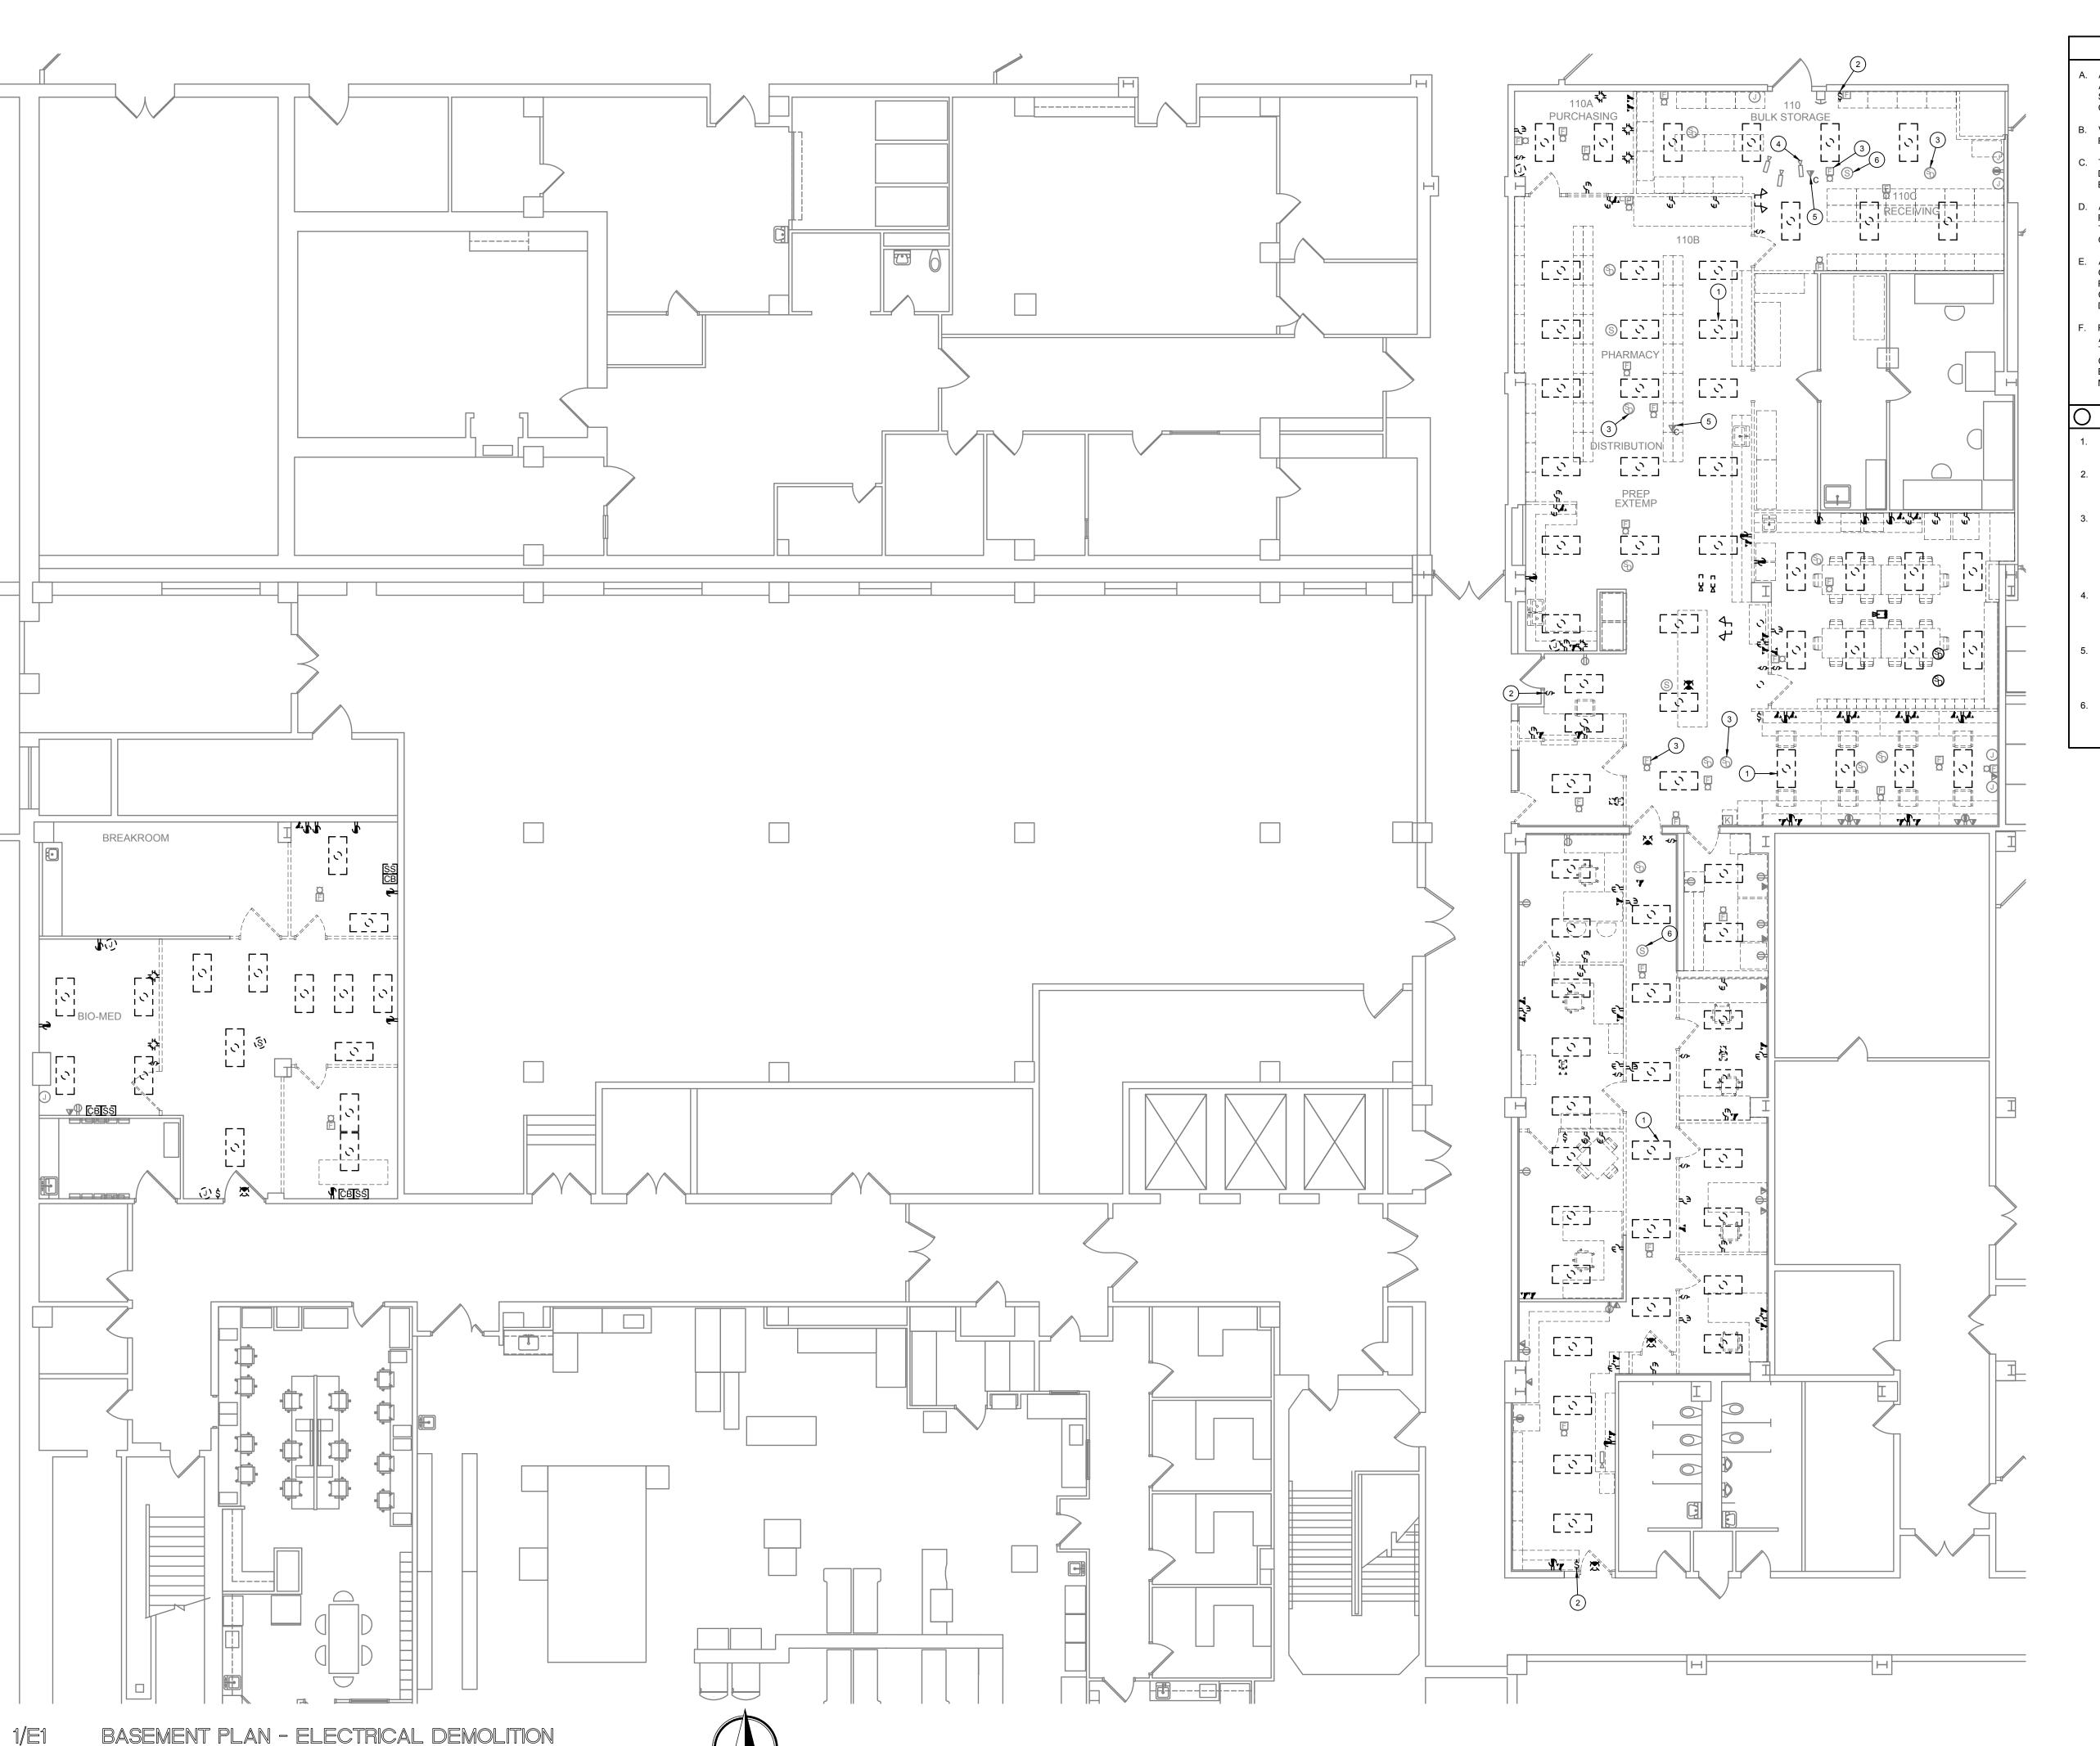
#### **KEYED NOTES**

- EXISTING LIGHT FIXTURE SHALL BE REMOVED. EXISTING CIRCUIT SHALL REMAIN FOR REUSE. (TYPICAL)
- EXISTING LIGHT SWITCH TO BE REMOVED AND REPLACED. EXISTING BACKBOX AND CONDUIT PATH MAY BE REUSED IF IN GOOD WORKING CONDITION.
- EXISTING FIRE ALARM DEVICES SHALL BE REMOVED AND RELOCATED TO NEW CEILING. ADJUST LOCATIONS TO ACCOMMODATE CONSTRUCTION. REFER TO POWER PLAN FOR NEW LOCATIONS. EXTEND AND CONNECT TO EXISTING FIRE ALARM CIRCUITS. COORDINATE REQUIREMENTS WITH UMC/TTUHSC. (TYPICAL)
- EXISTING CAMERA SHALL BE REMOVED AND RELOCATED TO NEW CEILING. EXTEND AND CONNECT TO EXISTING SECURITY CIRCUIT. COORDINATE REQUIREMENTS WITH SECURITY CONTRACTOR AND
- EXISTING WIFI UNIT SHALL BE REMOVED AND RELOCATED TO NEW CEILING. EXTEND AND CONNECT TO EXISTING COMMUNICATION CIRCUIT. COORDINATE REQUIREMENTS WITH UMC IT PERSONNEL (TYPICAL)
- EXISTING SPEAKER SHALL BE REMOVED AND RELOCATED TO NEW CEILING. EXTEND AND CONNECT TO EXISTING COMMUNICATION CIRCUIT. COORDINATE REQUIREMENTS WITH COMMUNICATION CONTRACTOR AND UMC (TYPICAL)



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UNIVERSITY MEDICAL CENTER
CENTRAL PHARMACY RENOVATION
& OFFICE RELOCATION
PROPOSAL ITEM #1

REVISIONS:

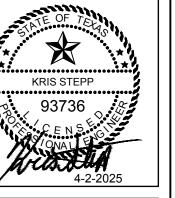
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PROJECT NO. 04/02/2025

SHEET NO. 1 OF 5

1/8" = 1'-0"

SCALE:

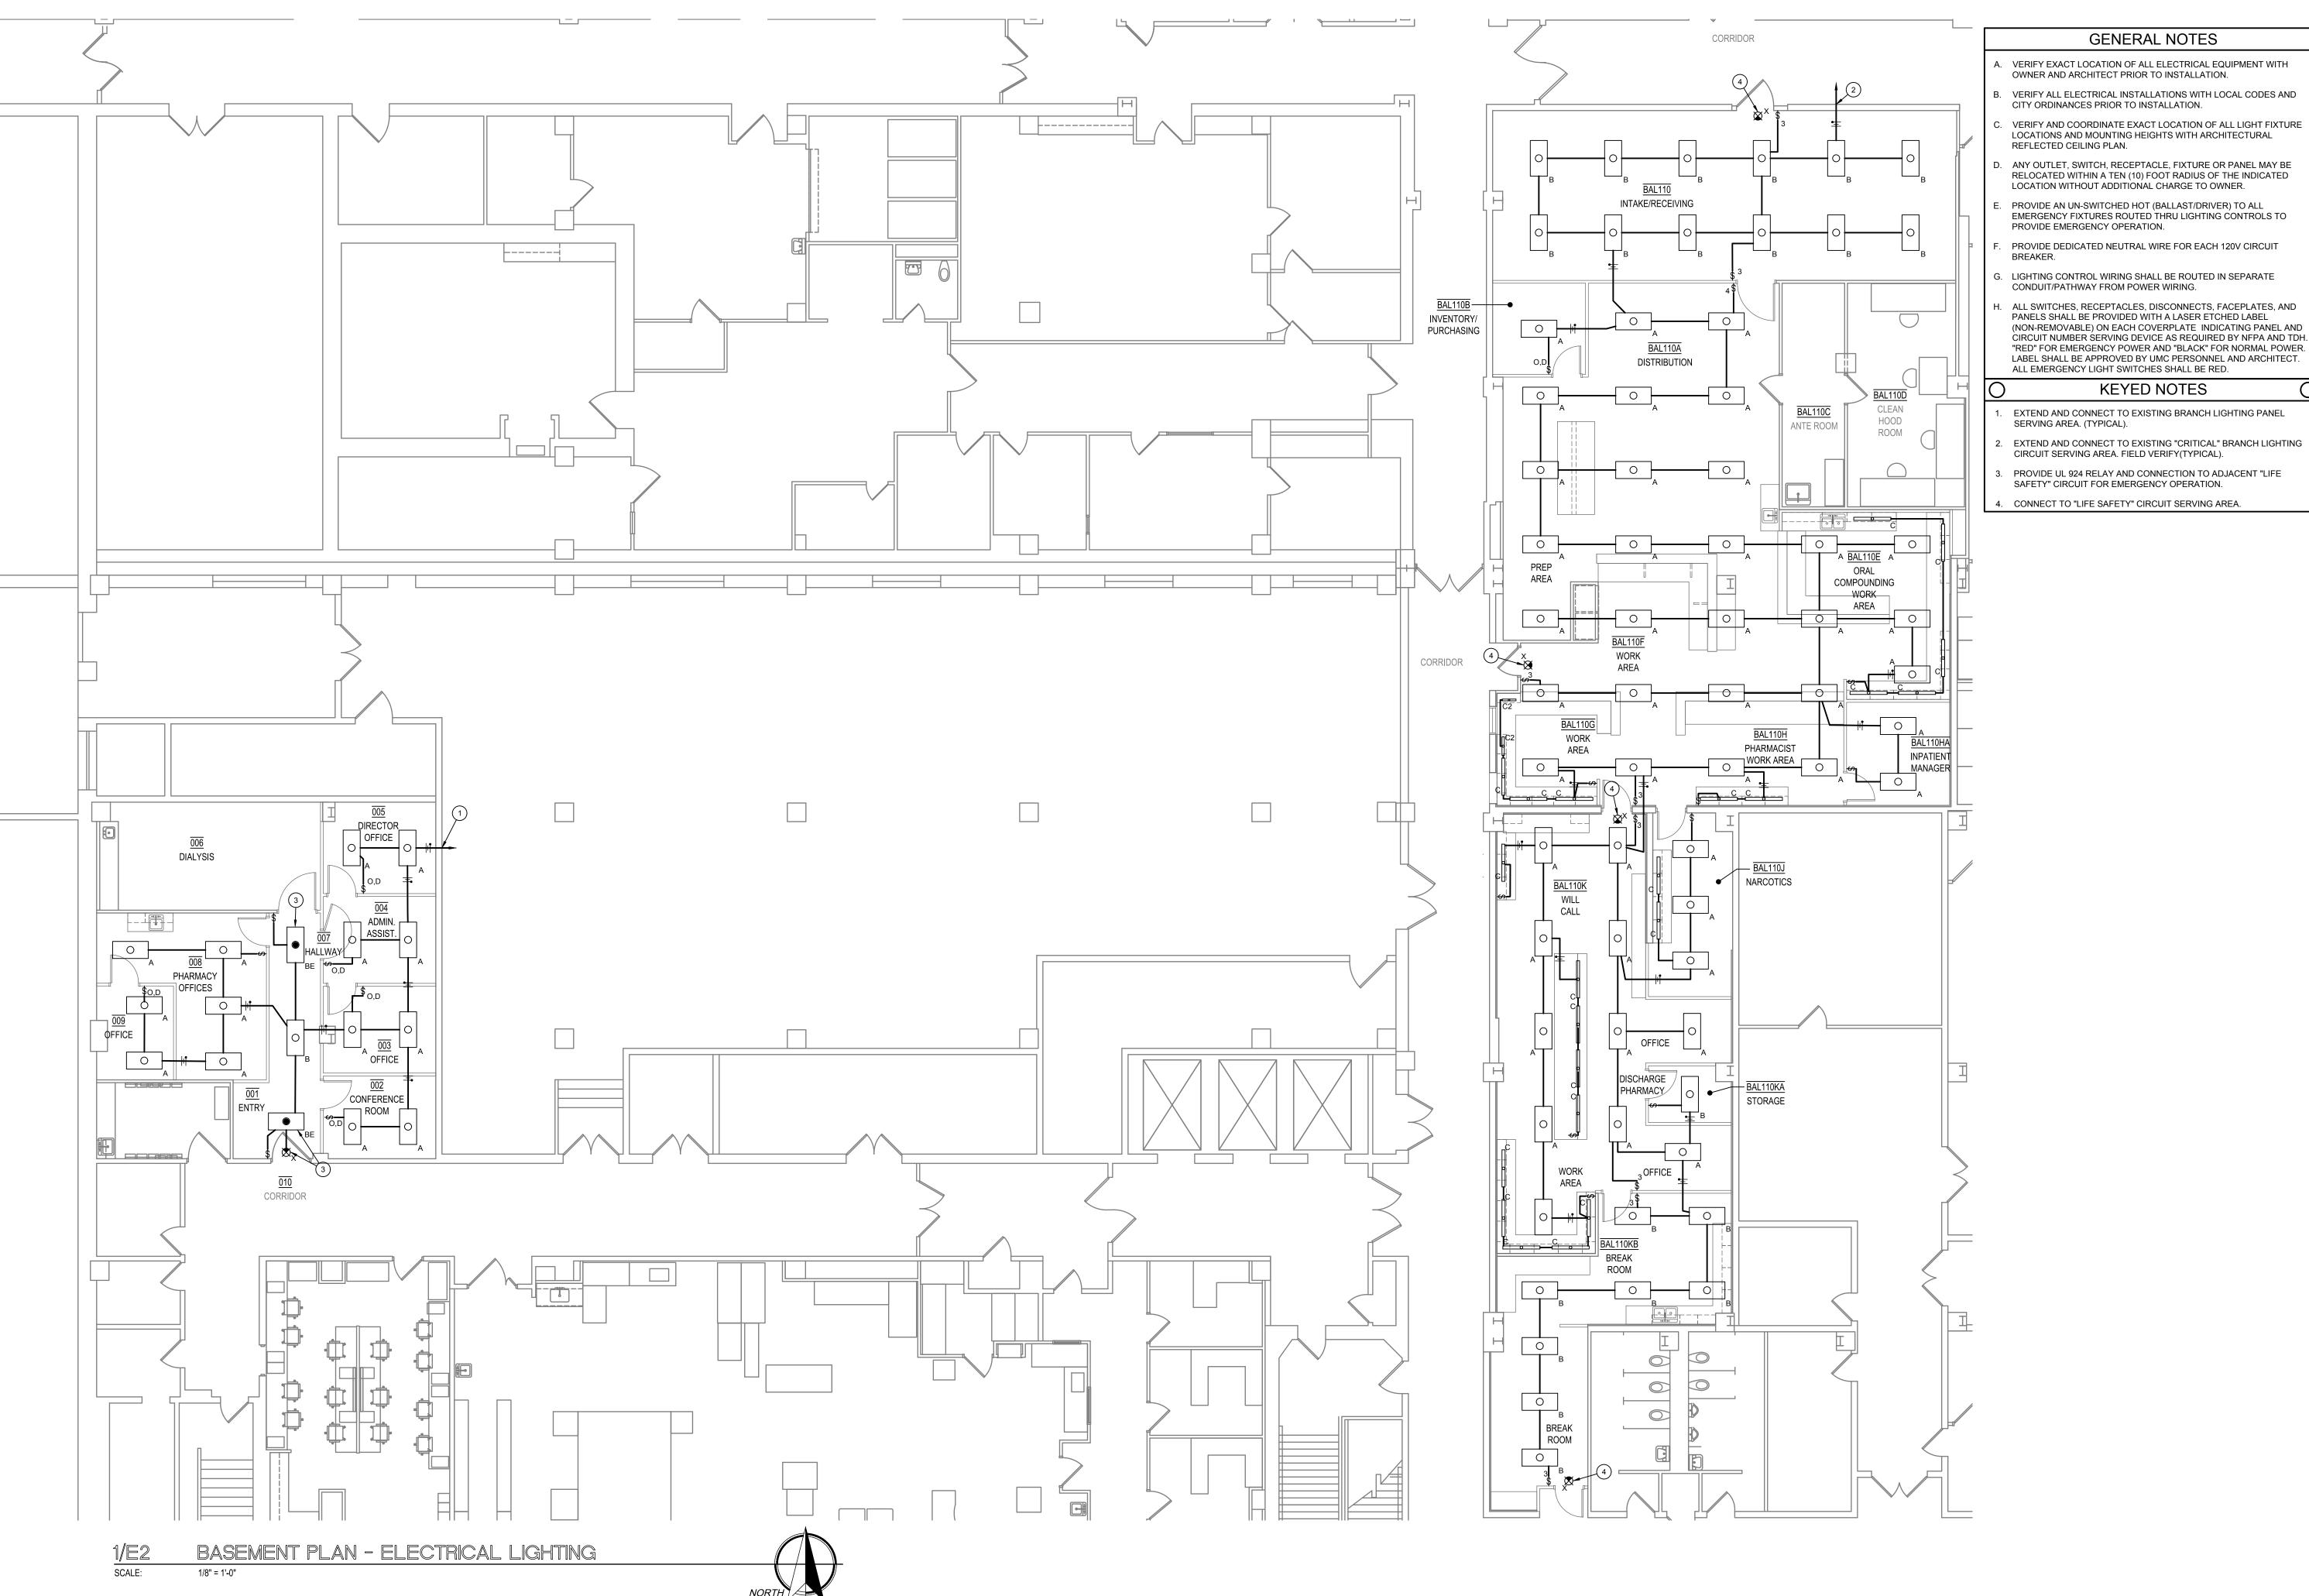


- B. VERIFY ALL ELECTRICAL INSTALLATIONS WITH LOCAL CODES AND
- VERIFY AND COORDINATE EXACT LOCATION OF ALL LIGHT FIXTURE
- ANY OUTLET, SWITCH, RECEPTACLE, FIXTURE OR PANEL MAY BE
- EMERGENCY FIXTURES ROUTED THRU LIGHTING CONTROLS TO

- ALL SWITCHES, RECEPTACLES, DISCONNECTS, FACEPLATES, AND PANELS SHALL BE PROVIDED WITH A LASER ETCHED LABEL
- (NON-REMOVABLE) ON EACH COVERPLATE INDICATING PANEL AND CIRCUIT NUMBER SERVING DEVICE AS REQUIRED BY NFPA AND TDH. "RED" FOR EMERGENCY POWER AND "BLACK" FOR NORMAL POWER. LABEL SHALL BE APPROVED BY UMC PERSONNEL AND ARCHITECT.



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SHEET NO. 2 OF 5

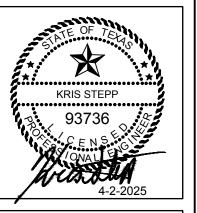


SCALE:

1/8" = 1'-0"



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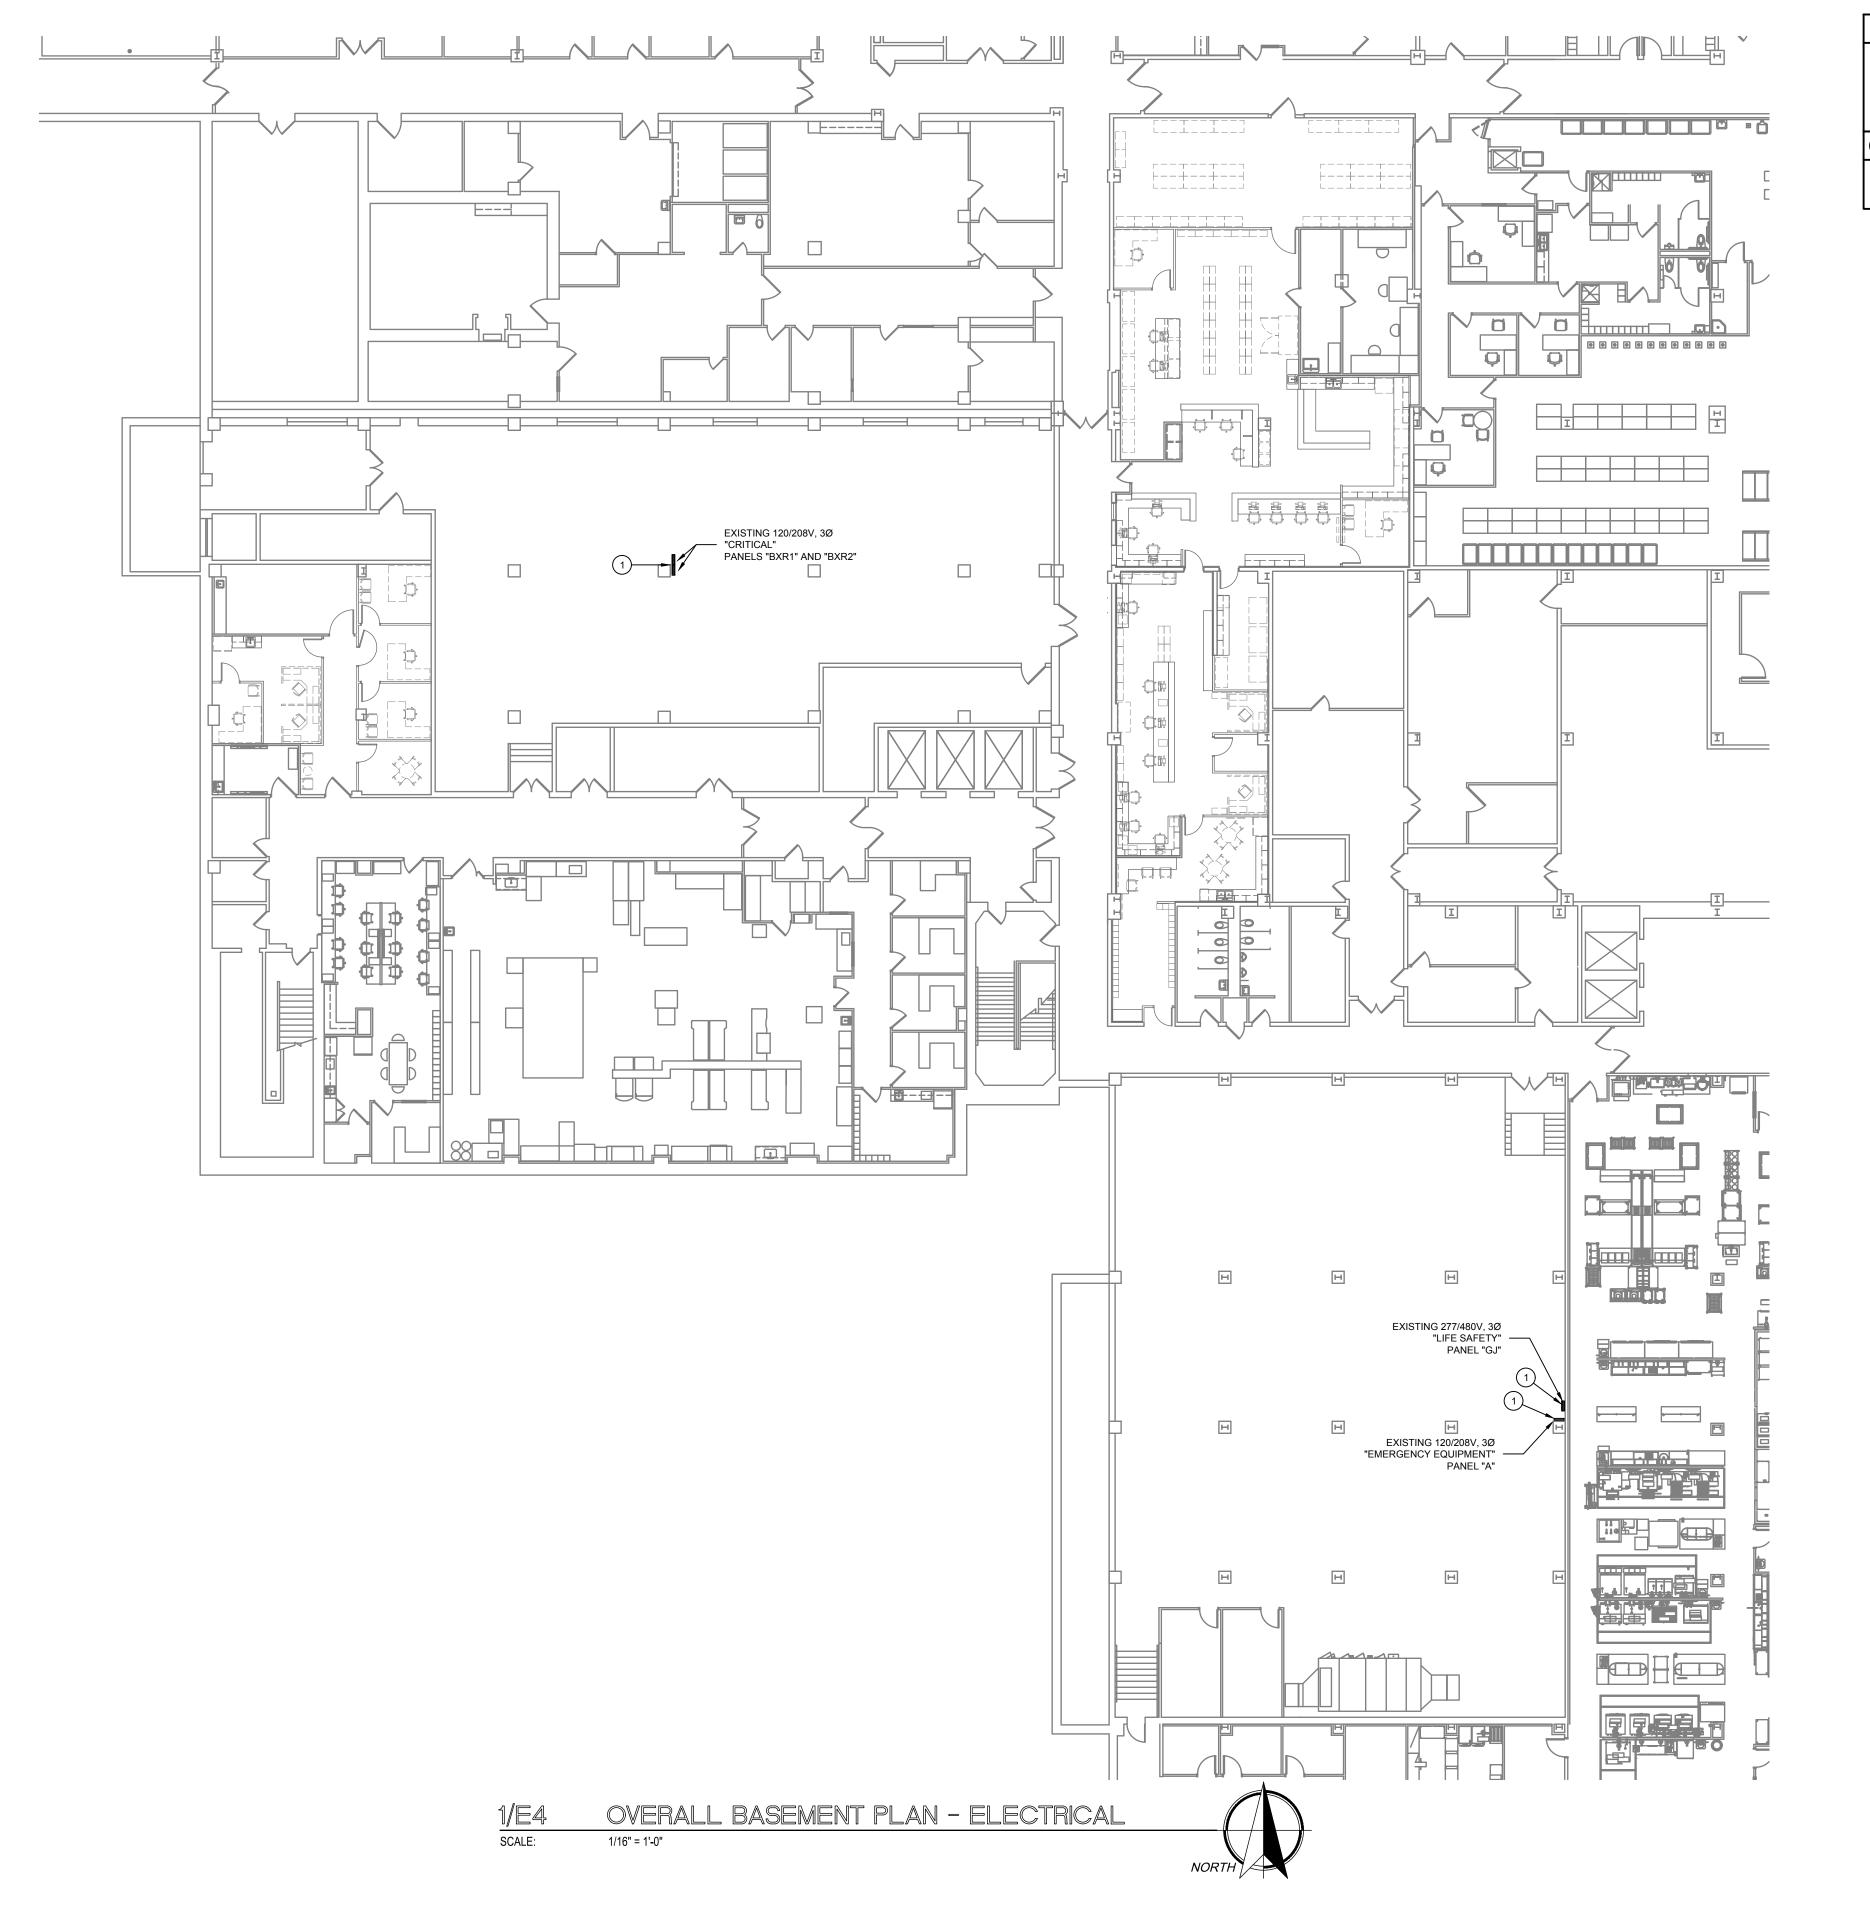
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PROJECT NO. 22304 DATE: 04/02/2025

SHEET NO.

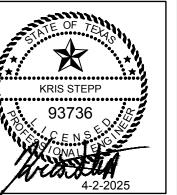

- A. VERIFY ALL ELECTRICAL INSTALLATIONS WITH LOCAL CODES AND CITY ORDINANCES PRIOR TO INSTALLATION.
- B. THE ELECTRICAL CONTRACTOR SHALL FIELD VERIFY EXISTING PANEL LOCATIONS AND CONDITIONS.


# **KEYED NOTES**

PROVIDE NEW TYPED INDEX CARD INDICATING LOADS AS REQUIRED



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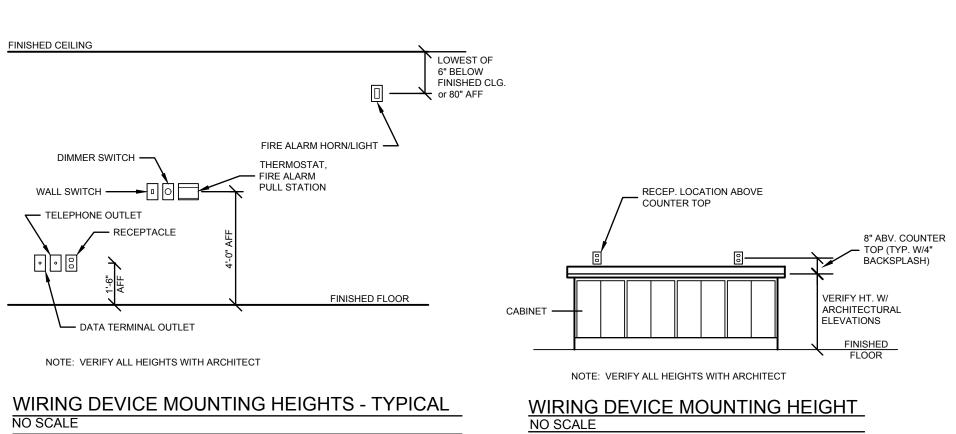



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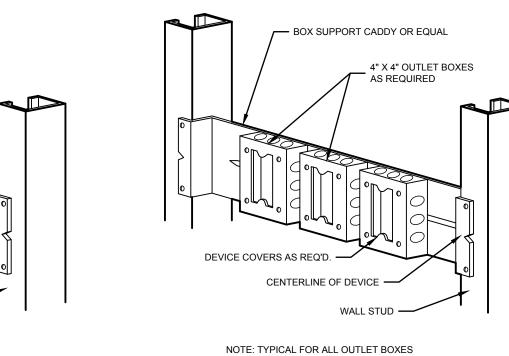
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PROJECT NO.

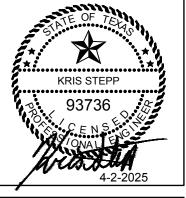04/02/2025 SHEET NO.





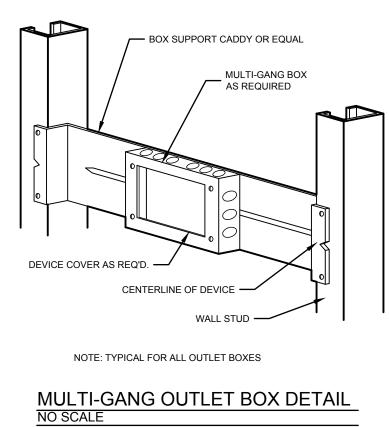

MULTIPLE	OUTLET	вох	DETA
NO SCALE			

	©		PHASE	#12	#12	#10	#10	#8	#8	#o	#o	#b	<del>#4</del>	#4	#2	#2	#1	#1/0	J#2/U	#3/0	#4/0	#350 KCMIL	#500 KCMIL
	$\frac{4}{3}$		NEUTRAL	#12	#12	#10	#10	#8	#8	#6	#6	#6	#4	#4	#2	#2	#1	#1/0	#2/0	#3/0	#4/0	#350 KCMIL	#500 KCMIL
$\left\{ \right.$			GROUND	#12	#12	#10	#10	#10	#10	#10	#10	#10	#8	#8	#8	#8	#6	#6	#6	#6	#4	#4	#3
	-		CONDUIT	3/4"	3/4"	3/4"	3/4"	1"	1"	1"	1"	1"	1-1/4"	1-1/4"	1-1/4"	1-1/4"	1-1/2"	2"	2"	2"	2-1/2"	3"	4"
•		'	NOTES: 1. UNLES 2. ALL 12 3. LOCAL	20V LIC	SHTING	AND F	OWER	CIRCU	IITS OV	/ER 75'	SHALL	BE #10	NHHT C	l.		IT SHAI	L BE S	SIZED F	ROM T	HIS CH	IART.		

NO SCALE


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25 | 30 | 35 | 40 | 45 | 50 | 60 | 70 | 80 | 90 | 100 | 125 | 150 | 175 | 200 | 225 | 300

WIRE AND CONDUIT SIZING CHART

TVDE	VOLTAGE	MOUNTING	MANUFACTUREF	R MODEL NUMBER	LAMPS (LM)	M/ATTS	REMARKS	NOTES	
ITPE	VOLTAGE	MOUNTING	WANUFACTURE	WODEL NOWBER	LAIVIPS (LIVI)	WATTS	REWARKS	NOTES	
Α	277	RECESSED	LITHONIA	ENVX 2X4 HRG 4800LM 80CRI 40K MIN10 MVOLT	4800	40	LED 2'X4' TROFFER		
AE	277	RECESSED	LITHONIA	ENVX 2X4 HRG 4800LM 80CRI 40K MIN10 MVOLT	4800	40	SAME AS TYPE "A" EXCEPT CONNECTED TO "LIFE		
AL	211	RECESSED	LITHONIA	ENVA 2A4 FIRG 4600LIN 60CRI 40R MINTO INVOLT	4600	40	SAFETY" CIRCUIT.		
В	277	RECESSED	LITHONIA	ENVX 2X4 HRG 3000LM 80CRI 40K MIN10 MVOLT	3000	25	CURVED LENS RECESSED 2'X4'		
BE	277	RECESSED	LITHONIA	ENIVY 2V4 LIDC 2000LM 200DL 40V MIN40 MVOLT	3000	25	SAME AS TYPE "B" EXCEPT CONNECTED TO "LIFE		
DE	211	RECESSED	LITHONIA	ENVX 2X4 HRG 3000LM 80CRI 40K MIN10 MVOLT	3000	25	SAFETY" CIRCUIT.		
С	277	SURFACE	NEW STAR	MUS4 HC L1 40 A UN	2500	25	48" UNDERCOUNTER LIGHT		
C2	277	SURFACE	NEW STAR	MUS2 HC L1 40 A UN	1250	12	24" UNDERCOUNTER LIGHT		
Х	277	SURFACE	LITHONIA	LE S 1 R ELN	LED		2	SINGLE FACED EXIT SIGN WITH EMERGENCY	
^	211	SURFACE	LITHONIA	LESTRELN	LED	2	BATTERY		
				GENERAL LIGHT FIXT	URE NOTES:				
A.	ALL LED LI	GHT FIXTURES	SHALL BE RATED	FOR 4000 DEGREES KELVIN UNLESS OTHERWISE	NOTED.				
				LIGHT FIXTURE SCHED	DULE NOTES	3:			

O A 2x4 RECESSED LIGHT FIXTURE	
AE	2x4 RECESSED LIGHT FIXTURE WITH BATTERY BACK-UP
<b>X</b> <sup>X</sup>	EXIT SIGN - NUMBER OF FACES INDICATED BY SHADING
\$	SPST WALL SWITCH
φ	DUPLEX RECEPTACLE - 20A, 125V, 2P, 3W, GROUNDING
<b>*</b>	DOUBLE DUPLEX RECEPTACLE - 20A, 125V, 2P, 3W, GROUNDING
J	JUNCTION BOX
	CIRCUIT RUN TO PANELBOARD - NUMBER OF WIRES SHOWN
	CIRCUIT INDICATOR
4	WALL MOUNTED TELEPHONE/DATA OUTLET
Ö F	FIRE ALARM STROBE UNIT
<b>⑤</b>	FIRE ALARM SMOKE DETECTOR
•	208V RECEPTACLE
	SECURITY CAMERA

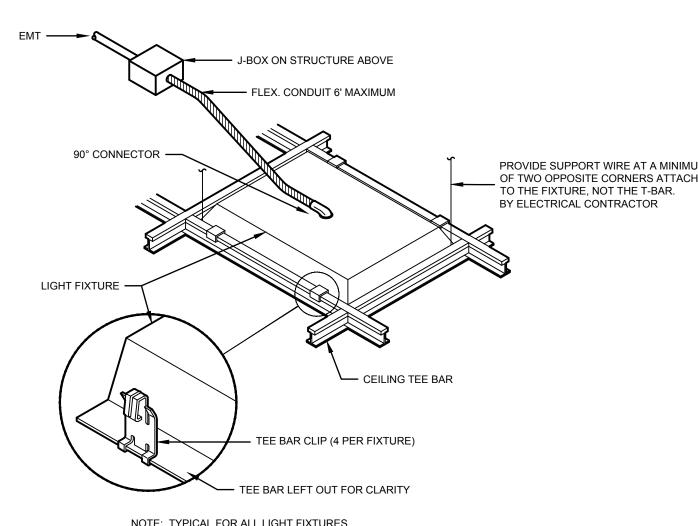

FLEX. CC	ONDUIT 6' MAXIMUM	
90° CONNECTOR		PROVIDE SUPPORT WIRE AT A MINIM OF TWO OPPOSITE CORNERS ATTAC TO THE FIXTURE, NOT THE T-BAR. BY ELECTRICAL CONTRACTOR
LIGHT FIXTURE		STEELS TRIONE GOVERNOOPER
	CEILING TEE BAR	
	R CLIP (4 PER FIXTURE) EFT OUT FOR CLARITY	
NOTE: TYPICAL FOR ALL LIGHT	FIXTURES	
<u>LAY-IN LIGHT FIX</u>	TURE DETAIL	

AMPERE AMPHOUR AMPERE INTERRUPTING CAPACITY ARC FAULT CIRCUIT INTERRUPTER AUTHORITY HAVING JURISDICTION AUTOMATIC TRANSFER SWITCH	AWG AMP AH AIC AFCI AHJ ATS
BATTERY BUILDING AUTOMATION SYSTEM	BAT BAS
CEILING COAXIAL CABLE COLOR RENDERING INDEX COMMUNICATIONS CONDUIT CONTROL COPPER CURRENT TRANSFORMER.	C COAX CRI COMM C CTRL CU CT
DECIBEL (SOUND) DEMOLITION DIRECT CURRENT DOUBLE POLE, DOUBLE THROW DOUBLE POLE, SINGLE THROW	dB DEMO DC DPDT DPST
ELECTRIC ELECTRICAL METALLIC TUBING ELECTRICAL NONMETALLIC TUBING	ELEC EMT ENT
FIRE ALARM ANNUNCIATOR PANEL FIRE ALARM CONTROL PANEL FLEXIBLE METALLIC CONDUIT FOOTCANDLE FULL LOAD AMPS	FAAP FACP FMC FC FLA
GAUGE GROUND GROUND FAULT CIRCUIT INTERRUPTER	GA GND GFCI
HORSEPOWER	HP
INTERMEDIATE METAL CONDUIT INTERNATIONAL BUILDING CODE	IMC IBC
KILOVOLT KILOVOLT AMP KILOWATT KILOWATT HOUR	kV kVA kW kWH
LIQUIDTIGHT FLEXIBLE METAL CONDUIT LIQUIDTIGHT FLEXIBLE NONMETALLIC CONDUIT LOW VOLTAGE LUMEN LUMENS PER WATT	LFMC LFNC LV LM LPW
MAIN CIRCUIT BREAKER MAIN LUGS ONLY	MCB MLO
MINIMUM MINIMUM CIRCUIT AMPS MOTOR CONTROL CENTER	MIN MCA MCC
NATIONAL ELECTRICAL CODE  NATIONAL ELECTRICAL MANUFACTURERS ASSOCIATION  NATIONAL FIRE CODE  NATIONAL FIRE PROTECTION ASSOCIATION  NOTIFICATION APPLIANCE CIRCUIT	NEC NEMA NFC NFPA NAC
PANELBOARD PHASE POLY VINYL CHLORIDE POWER FACTOR PUBLIC ADDRESS	PB PH PVC PF PA
RECEPTACLE RIGID GALVANIZED STEEL RIGID NONMETALLIC CONDUIT	RECEPT RGS RNC
SINGLE PHASE SINGLE POLE, DOUBLE THROW SINGLE POLE, SINGLE THROW SWITCHBOARD	1Ø SPDT SPST SWBD
THREE PHASE TELEPHONE TERMINAL BOARD	3Ø TTB
UNINTERRUPTIBLE POWER SUPPLY	UPS
VARIABLE FREQUENCY DRIVE VOLT, VOLTS, VOLTAGE VOLT AMPERE	VFD V VA
	WP

ELECTRICAL ABBREVIATIONS

ASTM

ABOVE COUNTER ABOVE FINISHED FLOOR

ALTERNATING CURRENT

AMERICAN WIRE GAUGE

AMERICAN NATIONAL STANDARDS INSTITUTE AMERICAN SOCIETY FOR TESTING AND MATERIALS



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